PB# 02-01

Benjamin Harris (SP) (Withdrawn)

13-5-29

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OFFICE BUILDING

TOWN OF NEW WINDSOR
PLANNING BOARD
Withdrawn COPY

Taconic Design CONSULTANTS, INC.

1 GARDNERTOWN ROAD * NEWBURGH, NY 12550 (845)-569-8400 * (fax) (845)-569-4583

DRAINAGE REPORT

for the

BEN HARRIS BUILDING

River Road Town of New Windsor Orange County, New York

Report prepared for:

Anthony J. Coppola, Architect 375 Third Street Newburgh, NY 12550

Report prepared by:

Taconic Design Consultants, Inc. 1 Gardnertown Road Newburgh, NY 12550 (845) 569-8400 October 1, 2002 Job #02355-AJC

I Commentary

1.0 Purpose:

The purpose of this study is to analyze the impacts, if any, which would be generated by a commercial site development known as "Ben Harris Building" located at River Road in the Town of New Windsor, Orange County, New York, and to develop a stormwater management plan for the site.

2.0 Project Description:

The proposed project is an office building on a 3.24 acre commercial building lot that is presently predominately meadow. The lot will have access from River Road, Old Route 9W and Union Avenue. Site plans, prepared by Anthony J. Coppola, RA for this project detail all improvements and sedimentary control measures and are a part of this report.

3.0 Quantitative Analysis:

This study analyses the pre-development and post-development storm drainage flows using the rational method per Town regulations. Quantitative storm water flows are evaluated.

3.1 Drainage Area:

The drainage area is the project site of the 3.24 acre site, 2.10 acres will become impervious due to the proposed development. This area drains into an existing culvert in the NYS DOT R.O.W.

3.2 **Soils**:

Based on the Orange County Soil Survey, it was determined that the soil within the drainage areas is as follows:

Symbol	Description	Hydrologic Group
MdB	Mardin	"C"

The runoff coefficient (C) is based on "C" soils.

3.3 Land Coverage:

The type of land coverage for the areas analyzed was determined by field investigation of this site and the soil survey. The area analyzed is presently predominantly meadow.

3.4 Analysis

The rational method is used to calculate the increased flows from development for a 24 hour 25 yr storm (per Town and NYS DOT regulations). A subsurface infiltration system is designed to accommodate this increased flow so the "No increased runoff" provision in Town codes and NYS DOT regulations is achieved. This system also accommodates the first flush and will reduce runoff to below predevelopment rates for the design storm.

4.0 Conclusion:

Based on the analysis and results set forth in this study and the associated reference material, it is the professional conclusion of the undersigned that the proposed commercial development "Ben Harris Building" will cause no adverse environmental impacts.

Respectfully submitted,

Charles T. Brown, PE Taconic Design Consultants

President NYS Lic. # 065996



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WATER AND SEWER SYSTEM REPORT

Proposed Building for Ben Harris River Road New Windsor Orange County, NEW YORK

PREPARED BY

Gilson Engineering Associates
15 Shea Knolls Ct.
Campbell Hall, New York 10916

September 16, 2002

JOHN D. GILSON, P.E. NY. STATE LICENSE NO. 60186

TABLE OF CONTENTS

Project Description

Sanitary System

- 1.0 PURPOSE
- 2.0 PROJECTED SEWAGE FLOW
- 3.0 CONSTRUCTION

Water System

- 1.0 PURPOSE
- 2.0 PROJECTED WATER FLOW
- 3.0 CONSTRUCTION

LIST OF DRAWINGS

Title sheet T-1 Site plans SP-2

Project Description

The Ben Harris Building project is located in the Town of New Windsor between the intersections of Old Route 9-W, River Road and Union Avenue. It is composed of a single (4) story office building (C-1 occupancy).

The proposed sewer connection is to be a 4" PVC gravity line connected to a manhole at the intersection of River Road and Union Boulevard.

The water for the site is to be connected to an existing 8" main in Union Avenue. The water will be used for light commercial purposes, (2) site fire hydrants (to be granted to the town) and a class-1 combined stand pipe and sprinkler system.

Sanitary System

1.0 PURPOSE

The purpose of this report is to detail the design considerations and construction of a sewage line for the Ben Harris Building project.

2.0 PROJECTED SEWER FLOWS

The projected sewage flow for the project is to be the same as the water usage determined in the water section of this report.

Peak flow = 88 GPM.

Average flow = 940 GPD

3.0 Construction

The proposed sewer connection is to be a 4" PVC gravity line connected to a manhole at the intersection of River Road and Union Boulevard, see SP-2 for details.

Water System

1.0 PURPOSE

The purpose of this report is to detail the design considerations and construction of a domestic water main for the Ben Harris Building project. This system will support the domestic water usage of the building and supply (2) fire hydrants on the periphery of the property and a fire protection system, see SP-2 attached.

2.0 PROJECTED WATER FLOW

The domestic water flow for this project is as follows:

The projected domestic water flow for the project was determined as follows:

Number of occupants= 200.

Proposed Plumbing Fixtures:

- (12) Toilets
- (9) Lavatories
- (3) Kitchen sinks
- (3) Water fountains
- (1) Hose bib

The peak water flow is 88 GPM based on plumbing code calculations.

The average water flow is 940 GPD based on 4.7 GPD per person.

Hydraulic calculations per NFPA-13 for sprinklers and NFPA-14 for stand pipe systems were performed and showed that the proposed water supply and piping arrangement were sufficient for proper operation without additional pumping equipment.

Fire hydrant flows when used are 250 GPM.

3.0 CONSTRUCTION

The water system for the project is to be fed from an 8" main in Union Boulevard through an 8" tap, which will feed (2) fire hydrants through an 8" pipe on the northeast perimeter of the property. The 8" water tap will also feed the building through a 6" pipe, see SP-1.

A 2" domestic water pipe will be split off the 6" water feed outside of the building.

A 6" combined class-1 standpipe and sprinkler feed will continue into the building.

There are no flood plains on the site, thus the backflow devices are above the 100-year floodplain.

Back flow preventers are to be specified on the building plans for the building domestic water and fire protection systems.

Final construction compliance certifications will include as-built drawings along with the testing of the back flow devices (form DOH-347).

A thony J. Coppola, R.A.

Design, Architecture and Planning copposes reflect@ao! ::n

J75 Third Street Newburgh, NY 12554

Tel: \$45-561-3559 Fmr: \$45-561-2051

Monday, January 27, 2003



Quantity Unit Price Total
g/Demolition \$ -30,000.00
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\$ -5,000.01
82,000 SF \$ 1.50 \$ 123,000.00
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2,500 LF \$ 11.00 \$ 27,500.00
220 SF \$ 5.50 \$ 1,210.00
e-Infilitation System \$\ \$ 20,000.00
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340,710



Anthon J. Coppola, R.A.

Design, Architecture and Planning

375 Third Stre .: Newburgh, N1 : 2550

Tel: 845-861-3559 Fax: 845-561-2051

copppolarchiteci@nol.com

Monday, January 27, 200.



PROJECT: BEN HARRIS - RIVER ROAD

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ENGINEER & PLANNING

Central Valley Real Estate, Inc.

PO Box 487 Cornwall-on-Hudson, NY 12520 PH (845) 629-4748

June 4, 2003

Via Hand Delivery by Nick Cardaropoli, Jr.

Ms. Myra Mason Planning Board Secretary Town of New Windsor 555 Union Ave. New Windsor, NY 12553

RE: P.B. #02-01 Site Plan Approval – River Road Location Original Applicant Benjamin Harris

Dear Ms. Mason:

In accordance with State law we respectfully request two 90 day extensions on the conditional site plan approval for the above referenced project. This time will be used to clear all conditions of the site plan approval.

As per our records this extension will bring the date of the conditional site plan approval to 1/20/04.

Please do not hesitate to contact me if you have any questions regarding the above.

Sincerely,

CENTRAL VALLEY R.E. INC

Nick Cardaropoli, Jr.

President

Cc: Mr. Anthony Coppola. R.A.



STATE OF NEW YORK DEPARTMENT OF TRANSPORTATION 4 BURNETT BOULEVARD POUGHKEEPSIE, NY 12603

WILLIAM D. FITZPATRICK, P.E. REGIONAL TRAFFIC ENGINEER (845) 575-6040

ROBERT A. DENNISON III, P.E. REGIONAL DIRECTOR

JOSEPH H. BOARDMAN COMMISSIONER

Richard A. Burns
NYSDOT Permits
112 Dickson Street
Newburgh, NY 12550

(845) 565-9762

10 January, 2003

Mr. Mark J. Edsall, P.E., P.P. Town of New Windsor Planning Board Engineer 555 Union Avenue New Windsor, NY 12553

Re: Ben Harris Office Building, River Road, T/ New Windsor

Dear Mr. Edsall,

NYSDOT has given conceptual approval for ROW access to the above referenced project. A Highway Work Permit may be issued pending local approval and submission of the ancillary paperwork. If I may be of further assistance, please advise.

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Kichard Al Burns, Permits

cc: Glenn Boucher, Traffic
Anthony Coppola, Architect

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ENGINEER & PLANNING

Date: 1/13/03 Time: 11:10:26 AM



STATE OF NEW YORK DEPARTMENT OF TRANSPORTATION 4 BURNETT BOULEVARD POUGHKEEPSTE, NY 12603

02-01

WILLIAM D. FITZPATRICK P.F. REGIONAL TRAFFIC ENGINEER (845) 575-6040

ROBERT A DENNISON III, P.L. REGIONAL DIRECTOR

POSUPHIE BO ARDMAN COMMISSIONER

Richard A. Burns
NYSDOT Permits
112 Dickson Street
Newburgh, NY 12550
2 (845) 565-9762

10 January, 2003

Post-It® Fax Note 7671	Date/10/07 Dages /
To Anthony Coppola	FrAm Rich Burns
Co /Dept.	co. Dot
Phone # 56/- 3559	Prione # 565-9762
Faxn 561-2051	Fax # 562-8572

Mr. Mark J. Edsall, P.E., P.P. Town of New Windsor Planning Board Engineer 555 Union Avenue New Windsor, NY 12553

Re: Ben Harris Office Building, River Road, T/ New Windsor

Dear Mr. Edsall.

NYSDOT has given conceptual approval for ROW access to the above referenced project. A Highway Work Permit may be issued pending local approval and submission of the ancillary paperwork. If I may be of further assistance, please advise.

Sincerely ORIGINAL SIGNED BY RICHARD A. BURNE

Richard A. Burns, Permits

cc: Glenn Boucher, Traffic
Anthony Coppola, Architect

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1/13/03 CC: M.E.



STATE OF NEW YORK DEPARTMENT OF TRANSPORTATION 4 BURNETT BOULEVARD POUGHKEEPSIE, N.Y. 12603

ROBERT A. DENNISON III, P.E. REGIONAL DIRECTOR

WILLIAM D. FIYZPATRICK, P.E. REGIONAL TRAFFIC ENGINEER (845) 575-6040

JOSEPH H. BOARDMAN COMMISSIONER

September 18, 2002

Mark Edsall Town of New Windsor Planning Board 555 Union Avenue New Windsor, NY 12553

RE: Ben Harris Proposal

Dear Mr. Edsall:

We have completed a preliminary review of the subject plans, submitted to us on August 27, 2002. We question the need for three access points. Access points should be minimized and the site plan should be designed as such. Just because there is frontage on a road does not mean a drive should be granted along all frontages.

If you have any questions, please contact me at (845) 575-6054.

Very truly yours,

Glenn T. Boucher Civil Engineer II

cc: Rich Burns, Permit Inspector, Residency 8-4

CC: M. Edsall A. Coppola





COUNTY OF ORANGE

EDWARD A. DIANA COUNTY EXECUTIVE

DEPARTMENT OF PLANNING

124 MAIN STREET GOSHEN, NEW YORK 10924-2124 TEL: (845)291-2318 FAX: (845)291-2533

> DAVID CHURCH, A.I.C.P. COMMISSIONER

ORANGE COUNTY DEPARTMENT OF PLANNING 239 L, M OR N REPORT

This proposed action is being reviewed as an aid in coordinating such action between and among governmental agencies by bringing pertinent inter-community and countywide considerations to the attention of the municipal agency having jurisdiction.

Referred by: Town of New Windsor Planning Board

Reference No.: NWT 02N

County I.D. No: 9-1-101

Applicant: Ben Harris

Proposed Action: SEQR Lead Agency Coordination: 26,700 Sq. Ft. Office Building

State, County, Inter-municipal Basis for Review: SEQR

Comments: We have no objection to the Town of New Windsor Planning Board assuming Lead Agency status under SEQR for the project referenced above.

Related Reviews and Permits:

County Action: Local Determination

Disapproved

Approved

Approved subject to the following modifications and/or conditions:

Date: September 4, 2002

Commissioner of Planning

cc: M.E. A.Coppola



for submittal to the: TOWN OF NEW WINDSOR PLANNING BOARD

Ben Harris	, deposes and says that he resides
(OWNER)	
iat 190 Route 9W PO Box 780, Corn	wall in the County of Orange
(OWNER'S ADDRESS)	
and State of New York	and that he is the owner of property tax map
(Scc. Block designation number(Sec. 13 Block 5	Lot) Lot29_) which is the premises described in
the foregoing application and that he authorizes:	
(Applicant Name & Address, if different	from owner)
	hird Street, Newburgh, NY 12550
(Name & Address of Professional Repre-	sentative of Owner and/or Applicant)
to make the foregoing application as described th	erein.
Date: 12/21/d	Owner's Signature
See Enite	Owner's Signature
Vitness' Signature	Applicant's Signature if different than owner
	Representative's Signature

THIS FORM CANNOT BE WITNESSED BY THE PERSON OR REPRESENTATIVE OF THE COMPANY WHO IS BEING AUTHORIZED TO REPRESENT THE APPLICANT AND/OR OWNER AT THE MEETINGS.

JAN - 2 21107.

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617.21 Appendix C

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State Environmental Quality Review SHORT ENVIRONMENTAL ASSESSMENT FORM For UNLISTED ACTIONS Only


PART I-PROJECT INFORMATION (To be completed by Applicant or Project sponsor) 1. APPLICANT /SPONSOR 2. PROJECT NAME River Rd Project <u>Ben Harris</u> 3. PROJECT LOCATION: New Windsor Municipality 4. PRECISE LOCATION (Street address and road intersections, prominent landmarks, etc., or provide map) Intersection of River Rd, Union Ave, and Old Route 9W 5. IS PROPOSED ACTION: New Expansion Modification/alteration 6. DESCRIBE PROJECT URIEFLY: Proposed Medical Office Building, three stories with a total square footage of 26,700 7. AMOUNT OF LAND AFFECTED: Initially _3 23 8. WILL PROPOSED ACTION COMPLY WITH EXISTING ZONING OR OTHER EXISTING LAND USE RESTRICTIONS? □ Yee □ No If No, describe briefly B. WHAT IS PRESENT LAND USE IN VICINITY OF PROJECT? Residential Industrial Commercial Agriculture Park/Forest/Open space Cother Describe: 10. DOES ACTION INVOLVE A PERMIT APPROVAL, OR FUNDING, NOW OR ULTIMATELY FROM ANY OTHER GOVERNMENTAL AGENCY (FEDERAL, STATE OF LOCALIT ☐ Yes X No If yee, list agency(s) and pormit/approvals DOES ANY ASSECT OF THE ACTION HAVE A CURRENTLY VALID PERMIT OR APPROVAL? No If yes, list agency name and permittapproval Yes 12. AS A RESULT OF PROPOSED ACTION WILL EXISTING PERMIT/APPROVAL REQUIRE MODIFICATION? ☐ Yes I CERTIFY THAT THE INFORMATION PROVIDED ABOVE IS THUS TO THE BEST OF MY KNOWLEDGE Ben Harris Date: 12-21-01 Applicant/sponsor name. Signature:

If the action is in the Coastal Area, and you are a state agency, complete the Coastal Assessment Form before proceeding with this assessment

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	D ANY TYPE I THRESHOLD IN 6 NYCRI	4, PART 617.12?	f yes, coordinate the	review process	nd use the FULL EAF.
S. WILL ACTION RECEIV may be supercoded by Yea X No.	E COORDINATED REVIEW AS PROVIDE another involved agongy.	d for unlibted ac	tions in 8 Nycra, F	PART 617.87	No, a negative dactoration
C1. Existing air qua	PLT IN ANY ADVERBE EFFECTS ASSOC lity, surface or groundwater quality or sion, drainage or flooding problems? Ex	quantity, noise leve	LLOWING: (Answers is, existing traffic pa	muy be handwrit items, solid wa	an, il ingible) ite production or disposa
C2. Aesthetic, agricu	itural, archaeological, historic, or other	natural or cultural ra	saurcos; or communit	y or neighborhod	d character? Expisin brist
C3. Vagetation or fau N/A	na, fiah, shoilfich or wildlife species, siç	inilicant hobitats, or	threatened or endang 	ered spealer? E	plain briefly:
C4. A community's ex	lating plans or goals as officially adopted	, or a change in use	v intensity of use of le	ind ar other natu	al resources? Explain brief
N/A					
	nt development, or releted activities like	ly to be induced by	he proposed action?	Expisin briefly.	
N/A					
C6. Long term, short t	erm, dumulative, or other offects not ido	ntified in C1-C5? Ex	lain briefly.		
N/A					
C7. Other Impacts (inc	luding changes in use of either quantity	or type of energy)?	Explain briefly.		
N/A					
S THERE, OR IS THERE	LIKELY TO BE, CONTROVERSY RELATING TO BE AND BELLATION OF THE PROPERTY OF THE	ED TO POTENTIAL A	DVERSE ENVIRONM	ENTAL IMPACTS	?
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ATTACHMENTS

- A. Flood Hazard Area Davelopment Permit Application Form.
- B. Certificate of Complianco Not in a flood zone


PLEASE NOTE:

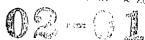Anthony J. Coppola, RA

IF PROPERTY IS NOT IN A FLOOD ZONE, PLEASE INDICATE THAT ON THIS FORM AND SIGN YOUR NAME. RETURN FORM WITH PLANNING BOARD APPLICATION.

IF PROPERTY IS LOCATED IN A FLOOD ZONE, PLEASE COMPLETE THE ATTACHED (LEGAL BLZE) PAPERS AND RETURN WITH PLANNING BOARD APPLICATION.

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New Office/Medical Office/Retail Building for Ben Harris River Road, Town of New Windsor, N.Y.

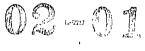	Town of New Windsor, N.Y.	
Requirements	Required	Actual
Minimum Lot Size	10,000 s.f.	3.23 acres
Lot Width	100 feet	590.3 feet
Front Yard Setback	40 feet	40 feet
Rear Yard Setback	15 feet	NA NA
Side Yard Setback	15 feet/35 feet combined	NA NA
Max. Building Height	35 feet	34 feet
Required Street Frontage	NA	NA
Floor Area Ratio	1	0.18
Development Coverage	NA	NA
Parking Space Size	9'-0"x19'-0"	9'-0"x19'-0"
Required HC Parking	6	9
Required Parking	178	178

Parking Calculation; 1 space per 150 s.f. =26,700 / 150 =178 spaces.

Required handicap parking is 6 spaces for less than 5 retail spaces. For 5 or more retail spaces, 178/20=9 handicap spaces would be required. 9 are provided at this time.

Floor	Area(s.f.)	Floor Elevation
Garage		480.00
First Floor	8900	491
Second Floor	8900	502
Third Floor	8900	513
Roof (flat)		524
Total	26700	

Schedule Of Architectural Drawings:

T1 Title Sheet & General Notes

SP1 Site Plan

SP2 Site Grading & Drainage Plan

SP3 Site Utility Plan


SP4 Site Landscaping Plan

SP5 Site Lighting Plan

SP6 Site Details

SP7 Site Details

SP8 Site Details

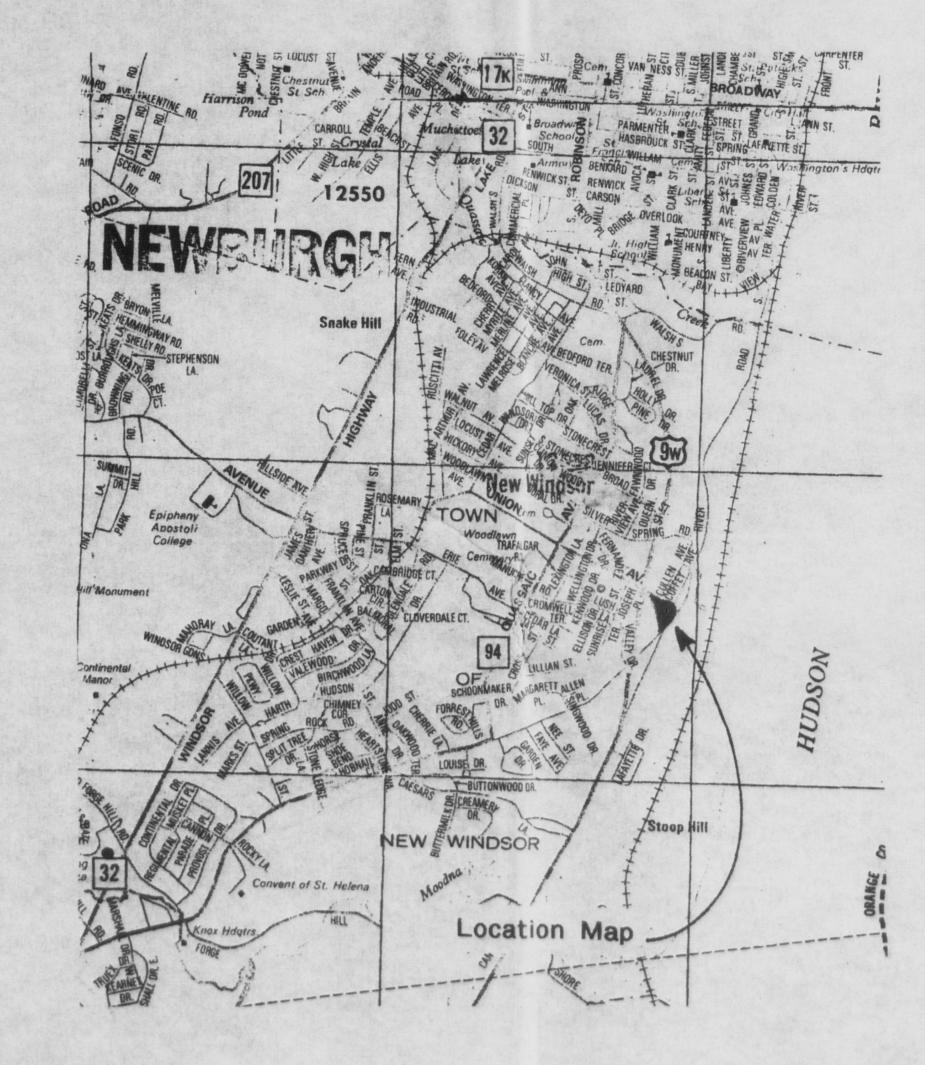

Site Plan Notes:

- 1. The proposed building is for a four story retail office building, allowable under uses A1-A4 of the Town of New Windsor Zoning Ordinance. The proposed building will be sprinklered.
- 2. The project applicant is Ben Harris Realty, 3062 U.S. Route 9W South, Suite 100, New Windsor, New York.
- 3. All building signs shall conform to the Town of New Windsor sign ordinance Section 48-18H.

Boundary and Topographical information from an original survey by Eustance and Horowitz, P.C. dated March 20, 1995.

Received Office/Medical Office/Redail Build Buil


02-01

Iony J. Coppola Architecture and Plann 75 Third St., Newburgh, N.Y. 12550 845-561-3559 Fax: 845-561-2051

Design, Architectur 375 Third St., Newbur Tel: 845-561-3559



Garage Plan
SP1 1"=30'-0"

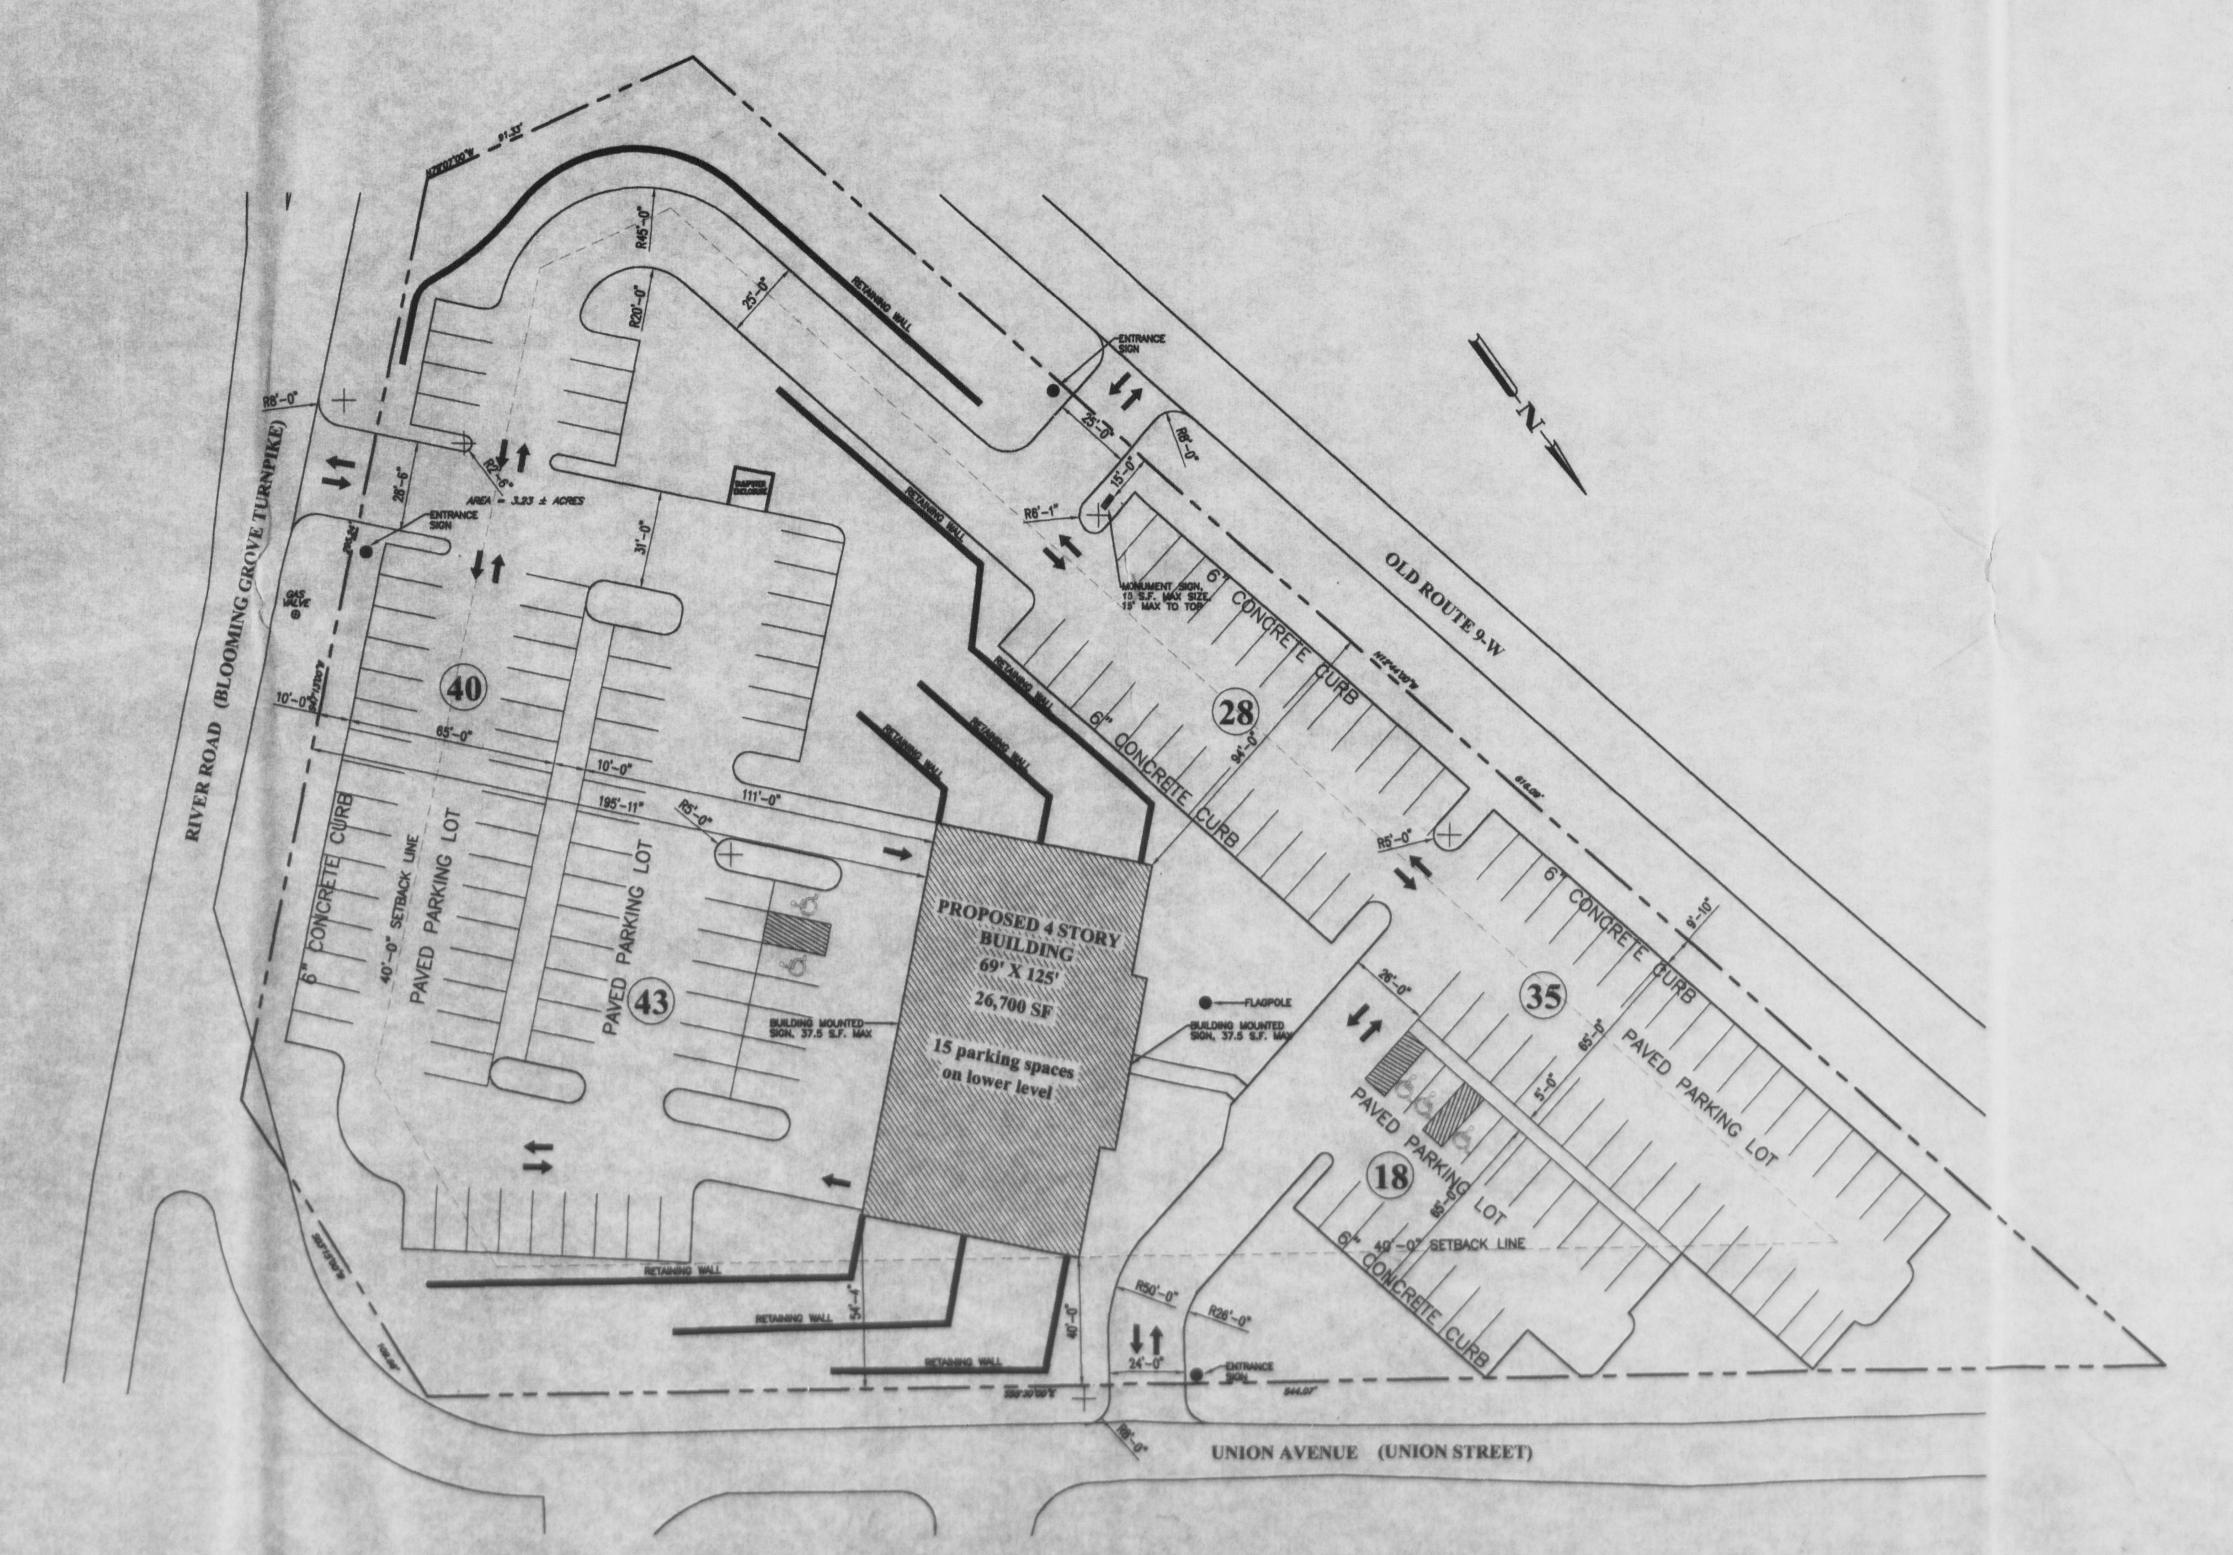

Site Plan

Anthony

Road River


Revisions 1/24/03

Drawn By: AJC Date:

AS NOTED

01-66

Sheet No.

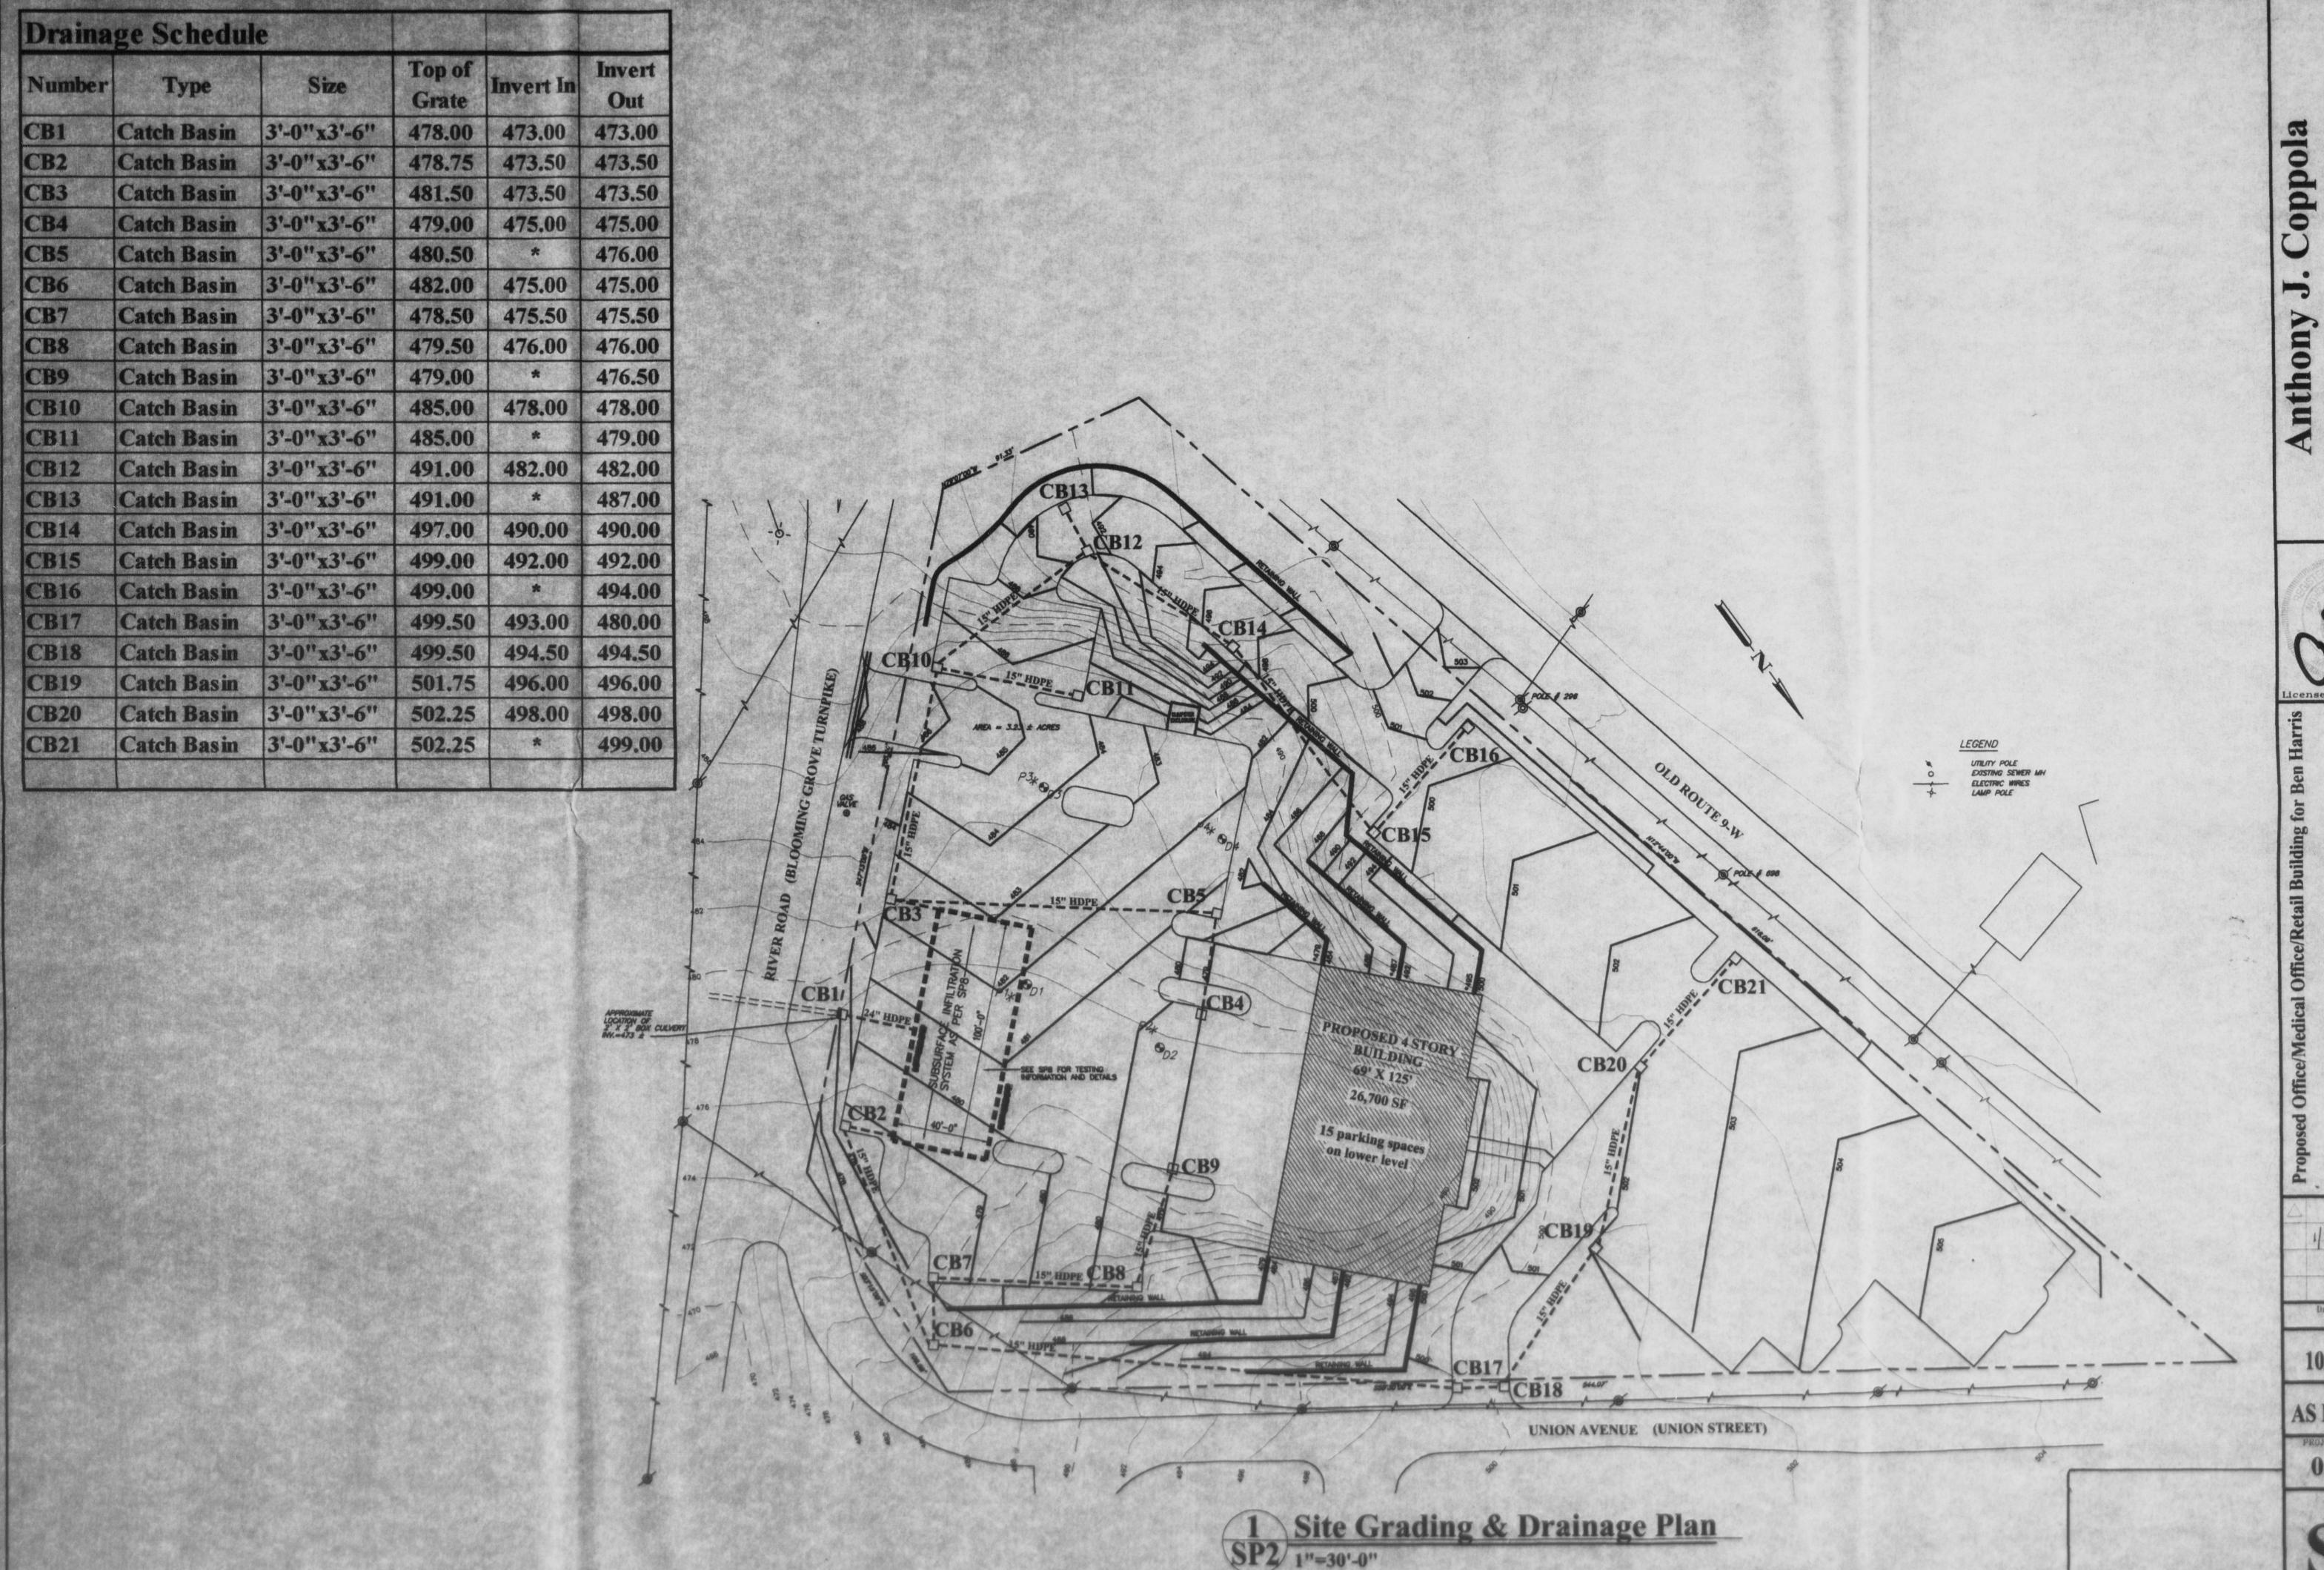



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AS NOTED





Anthony

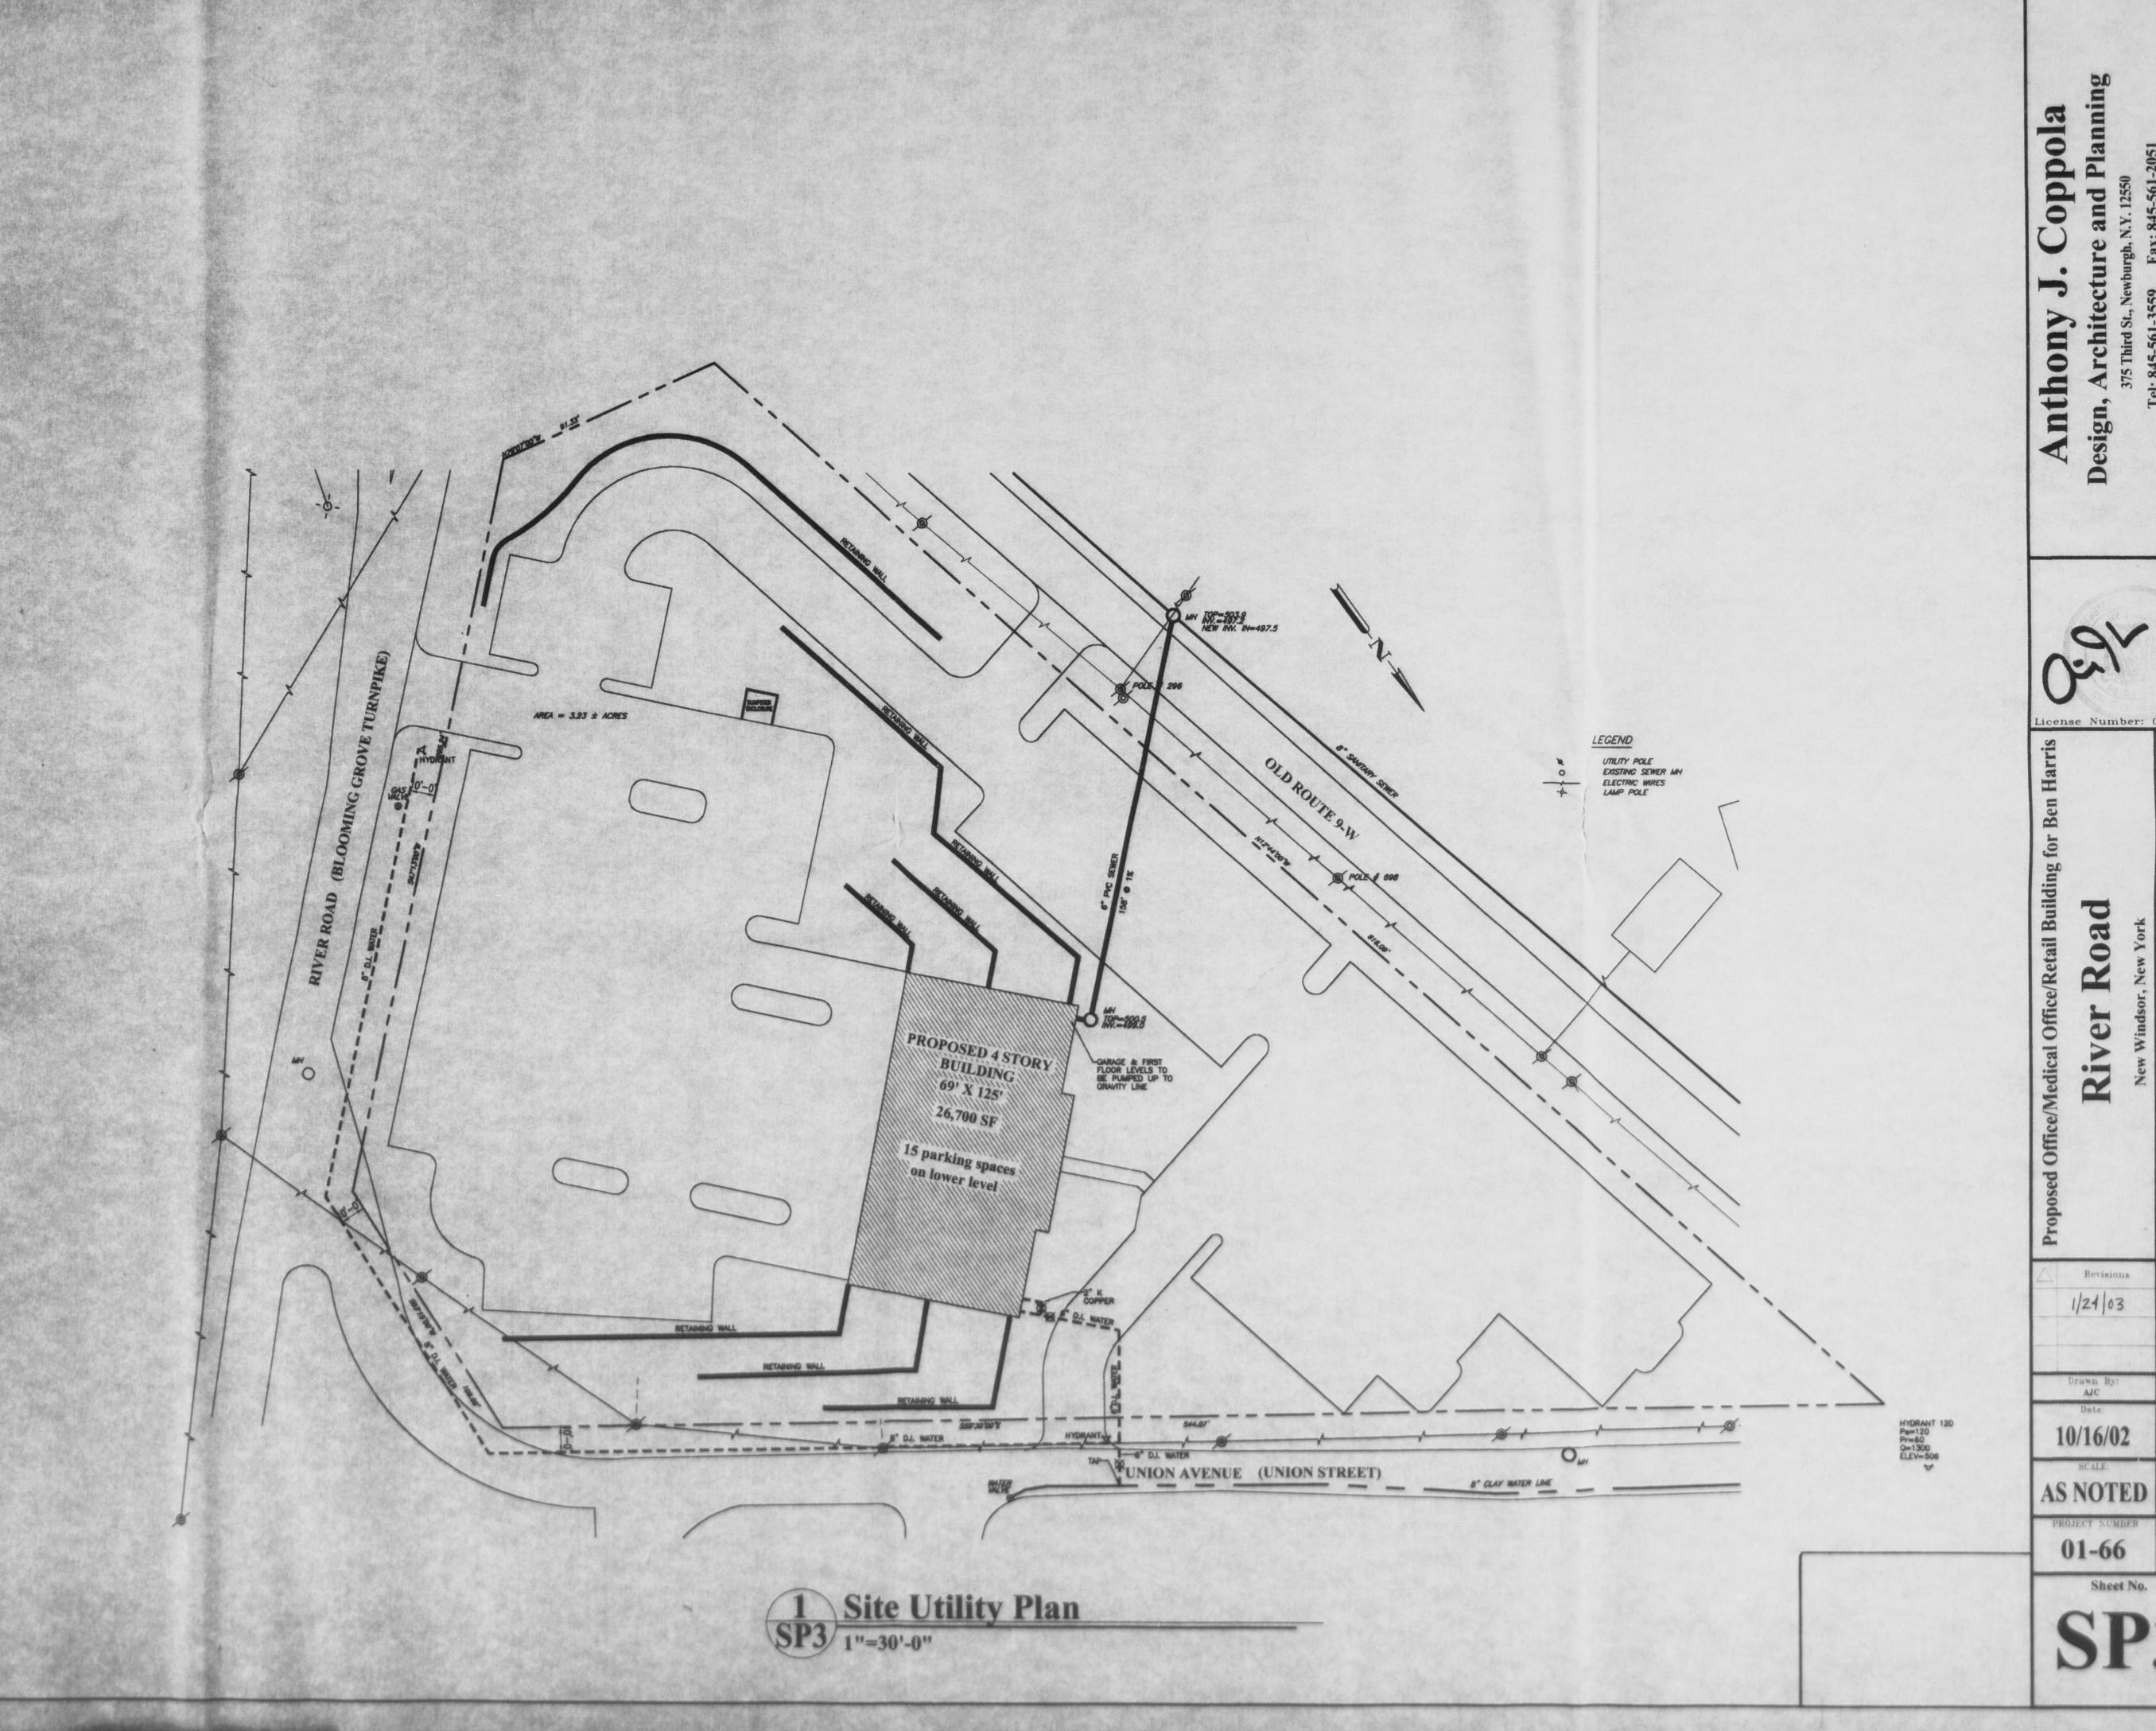Road
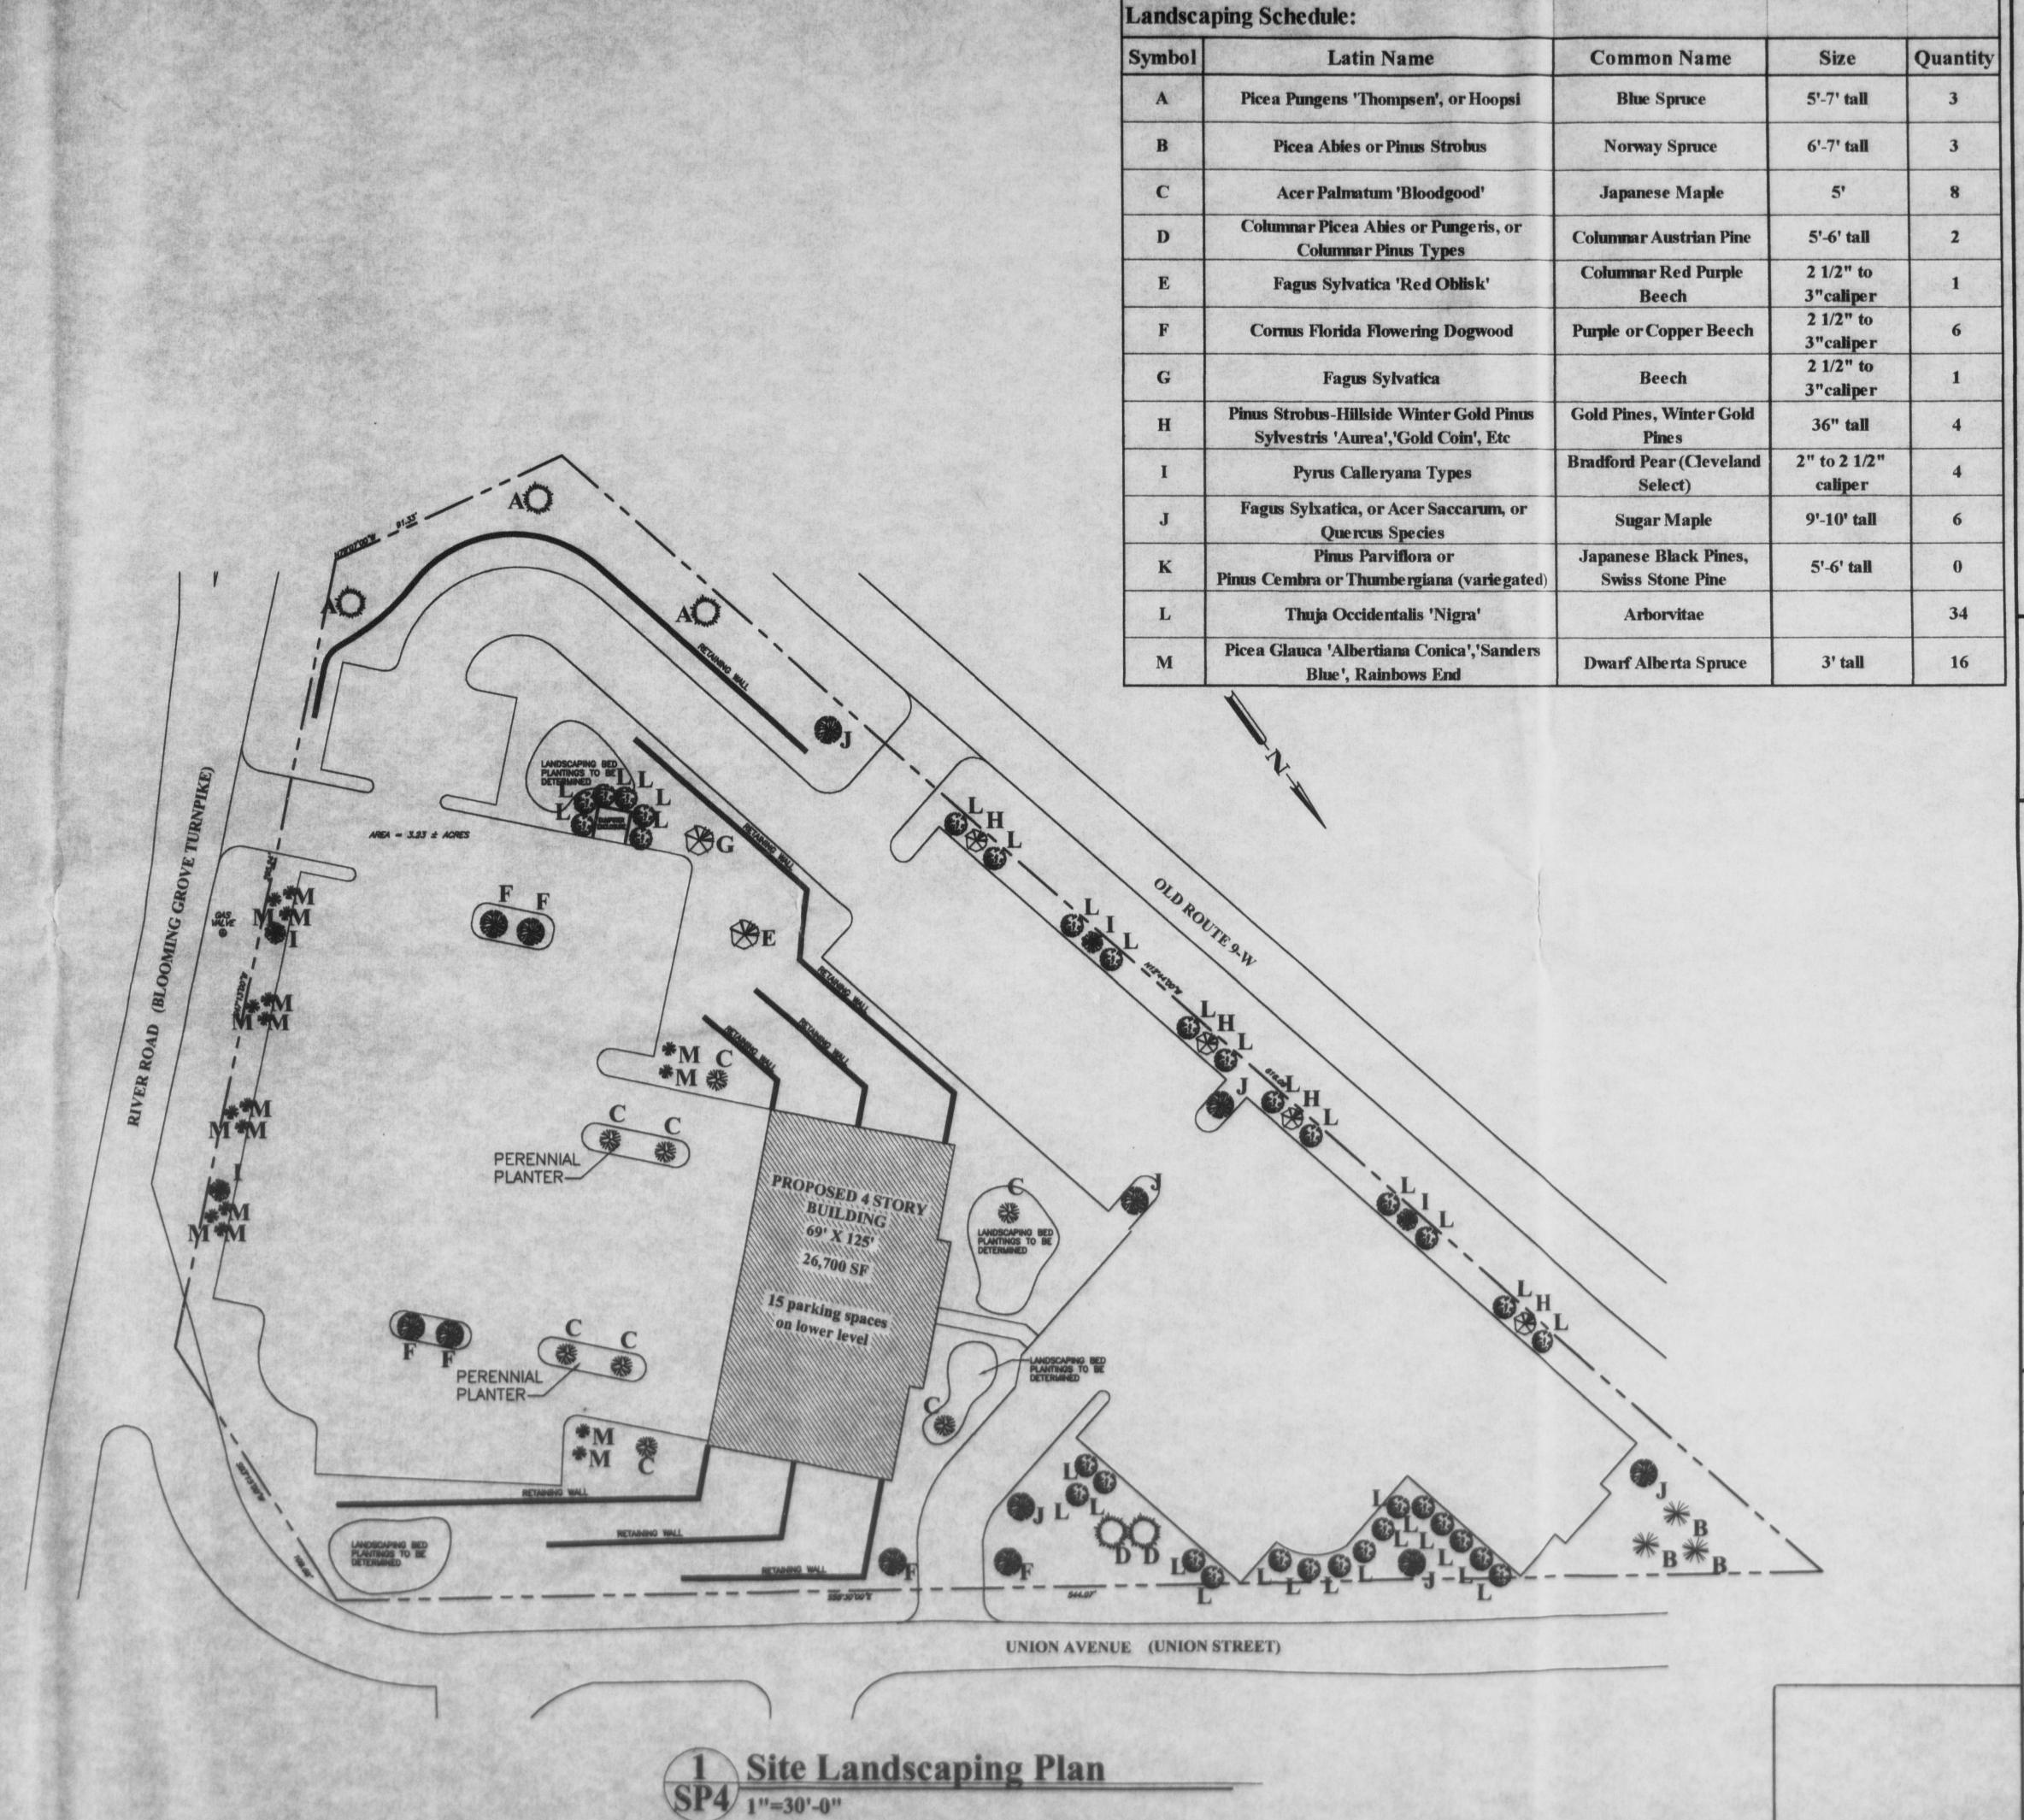
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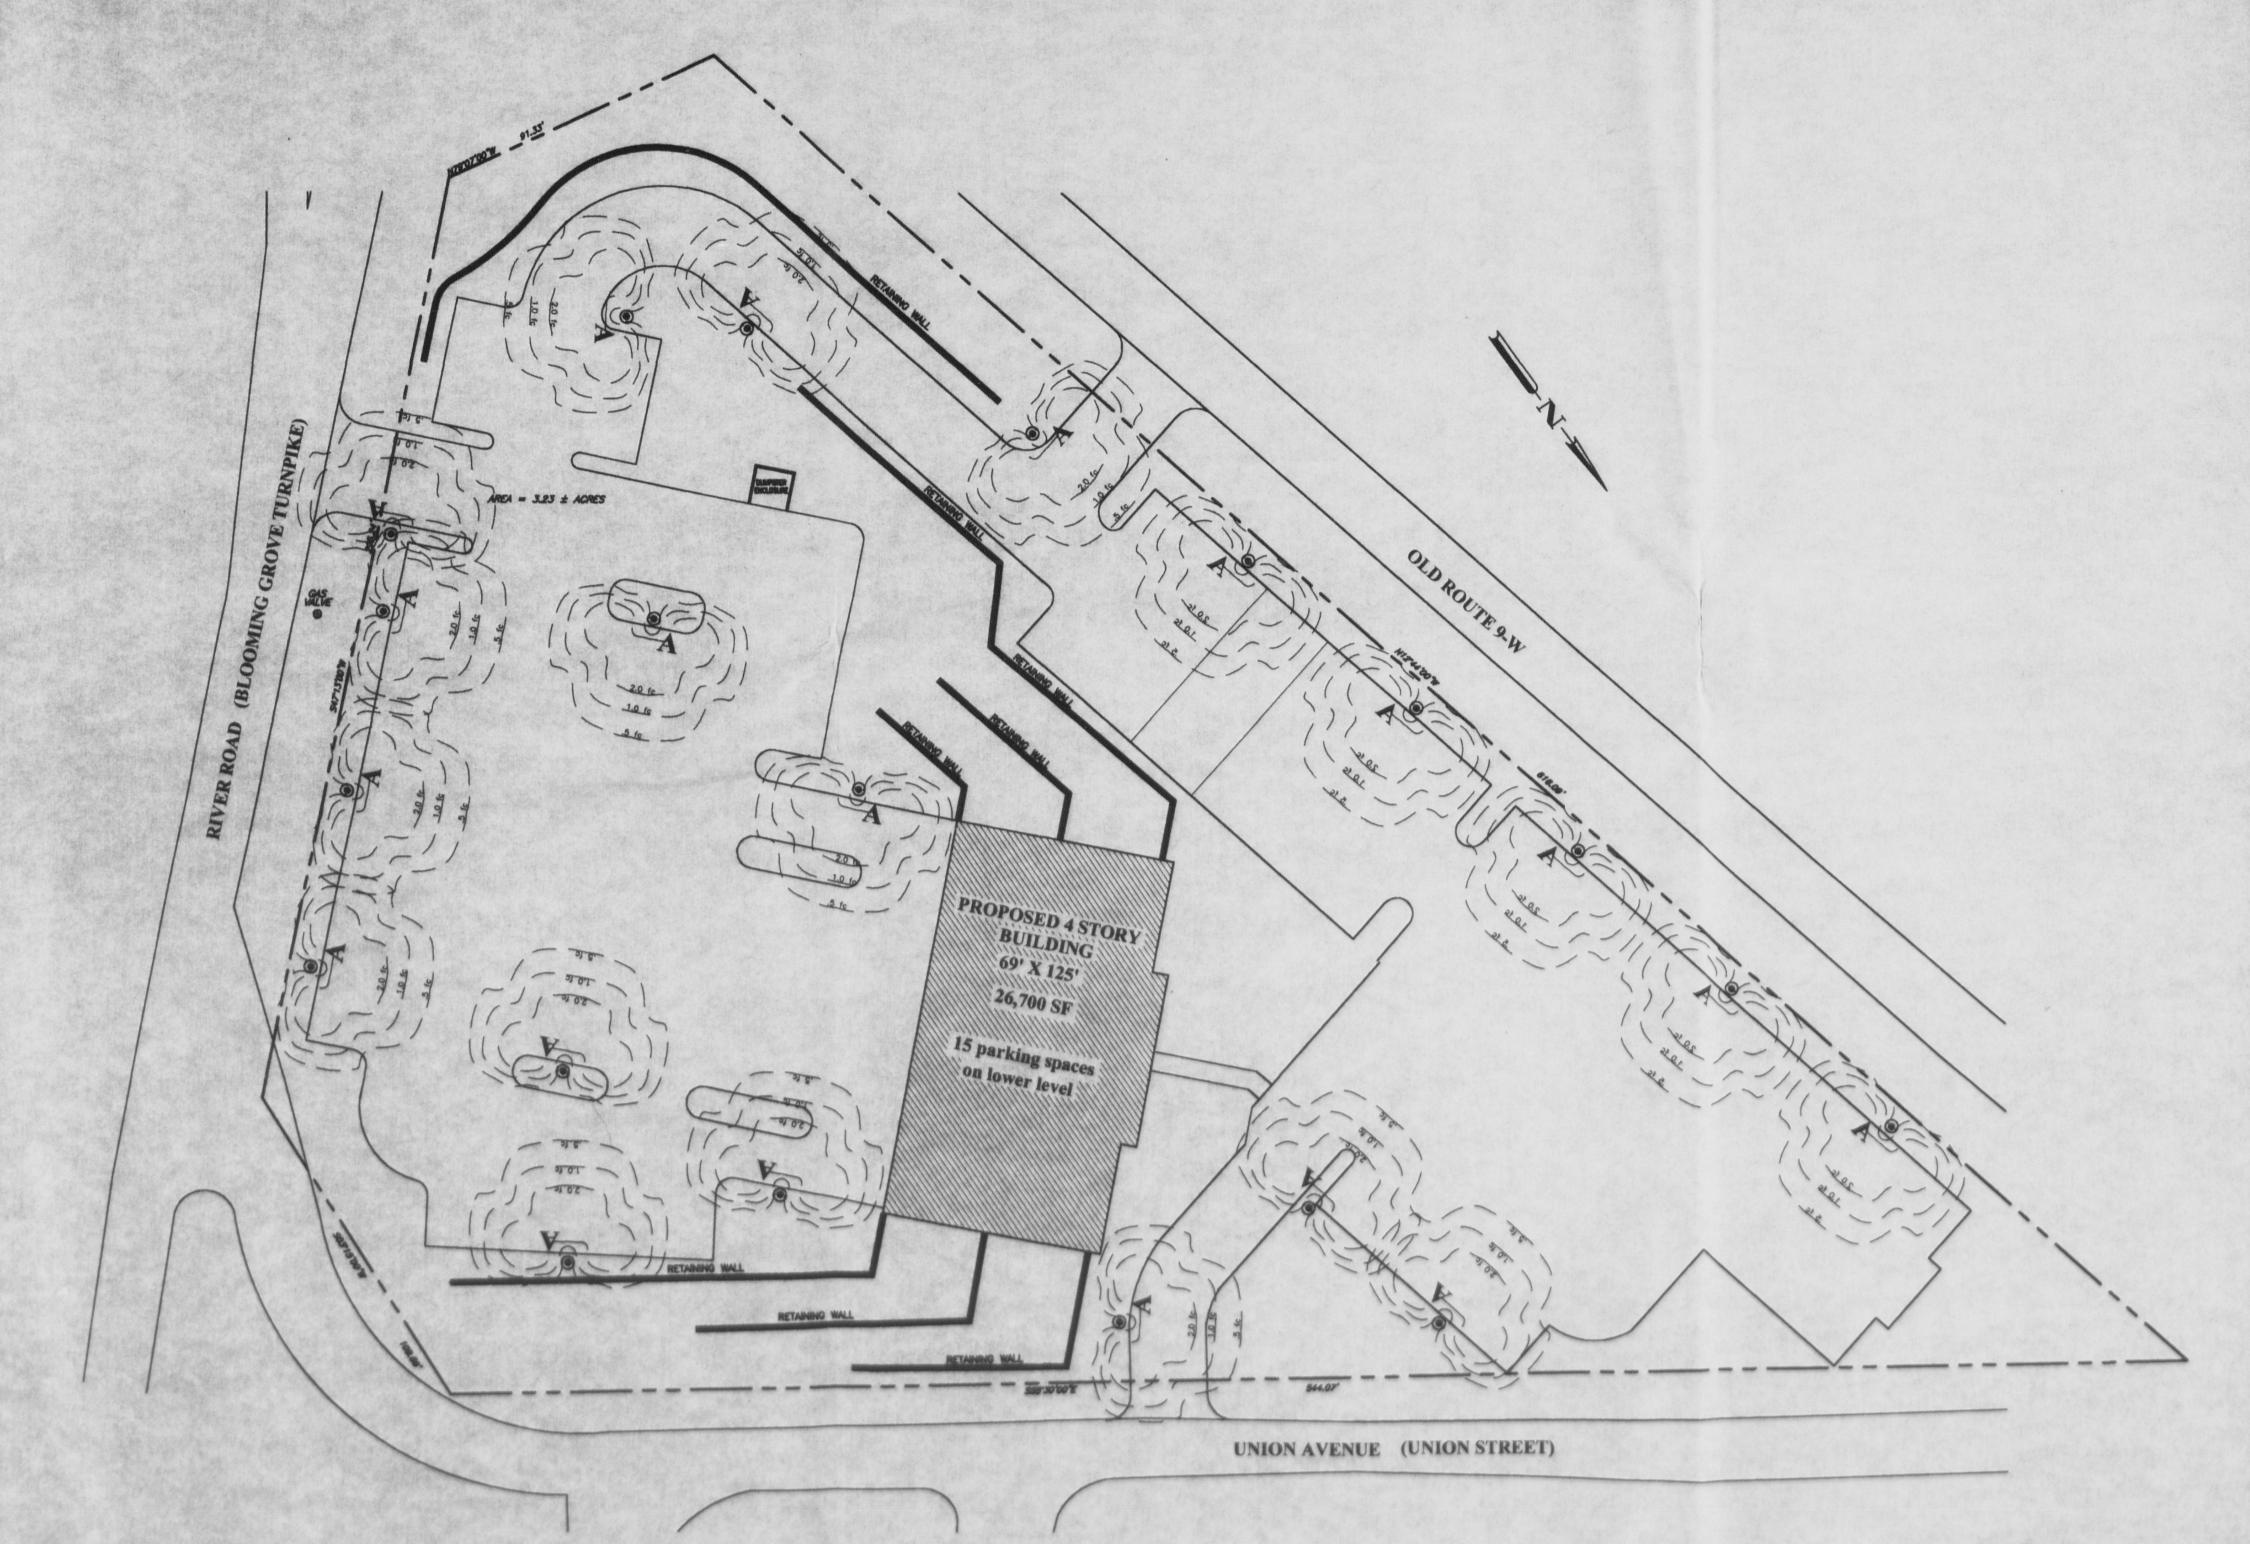
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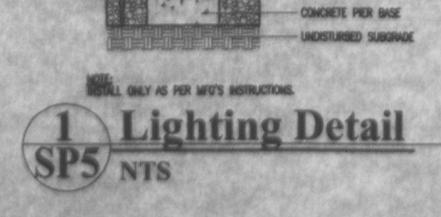
AS NOTED

Site Lighting Schedule					
Label	Quantity	Mounting Height	Catalog Number	Detail #	
A	A 20 15'-0" Lumec 150MH-L40-PCC-SGFM-X-1/RA41-1		Lumec 150MH-L40-PCC-SGFM-X-1/RA41-15-DK	5-DK 1/SP5	

Site Lighting Notes:

1. All parking lighting as manufactured by Thomas Lighting Co., distributed by Pyramid Lighting Group., (914) 699-1996





150W METAL HALIDE FORWARD THROW FIXTURE




Road River


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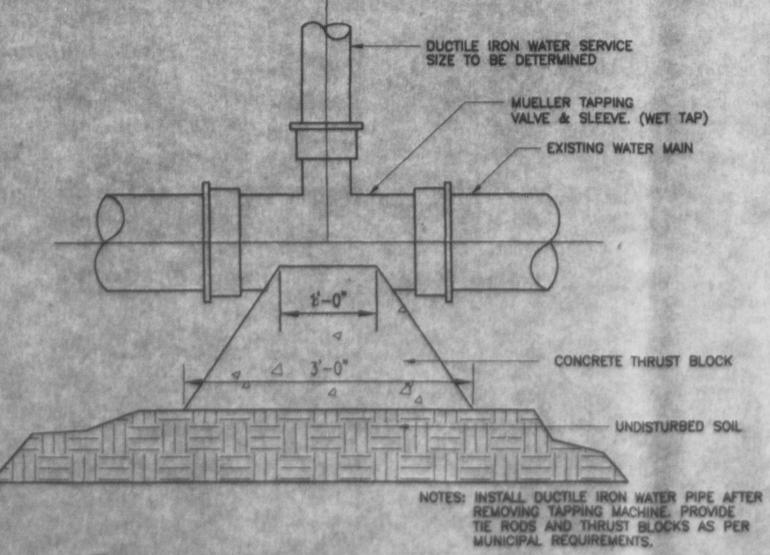
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AS NOTED






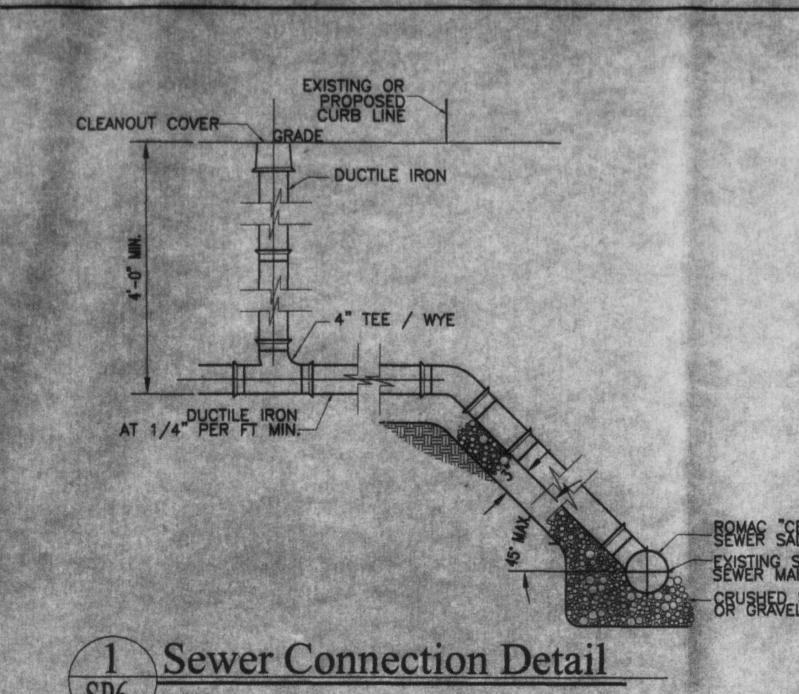


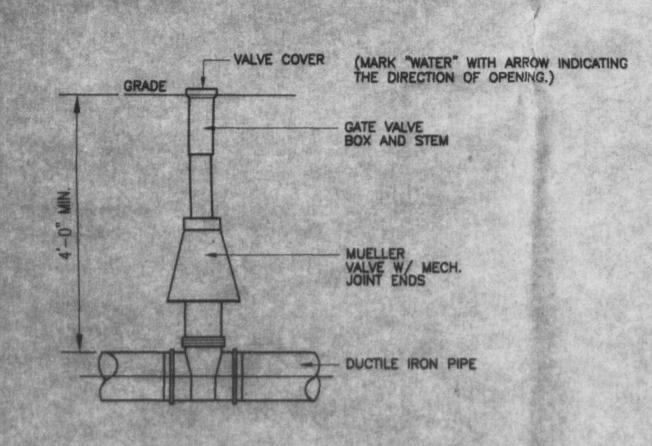


Water Tap Detail
SP2 NTS

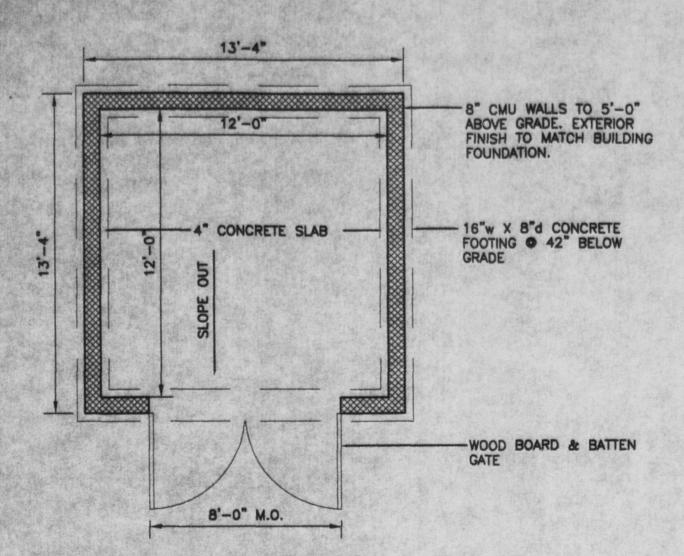

2 C.M.U. Enclosure Detail
SP6 Scale: 1/4"= 1'-0"

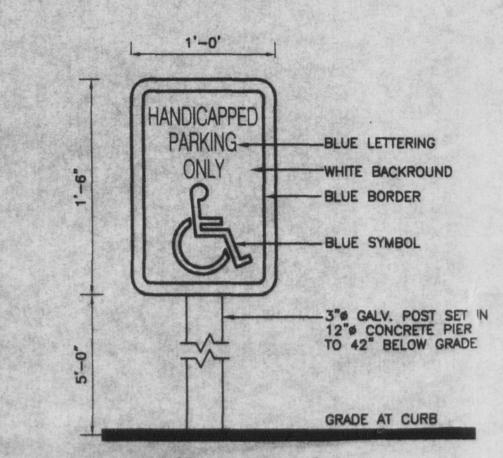


Handicapped
Parking Sign Detail
SP6 Scale: 1 1/2"= 1'-0"

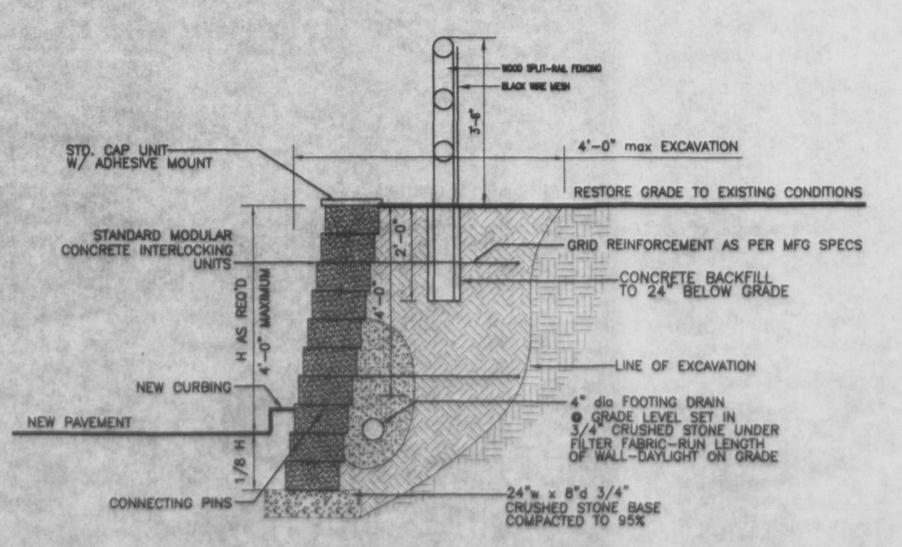


Typical Railing & Retaining Wall Detail

SP6 NTS

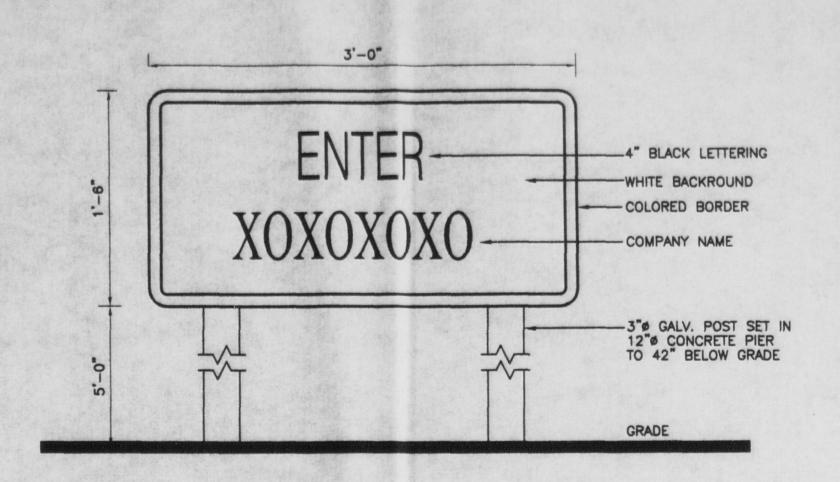

6 Entrance Sign Detail
SP6 Scale: 1 1/2"= 1'-0"

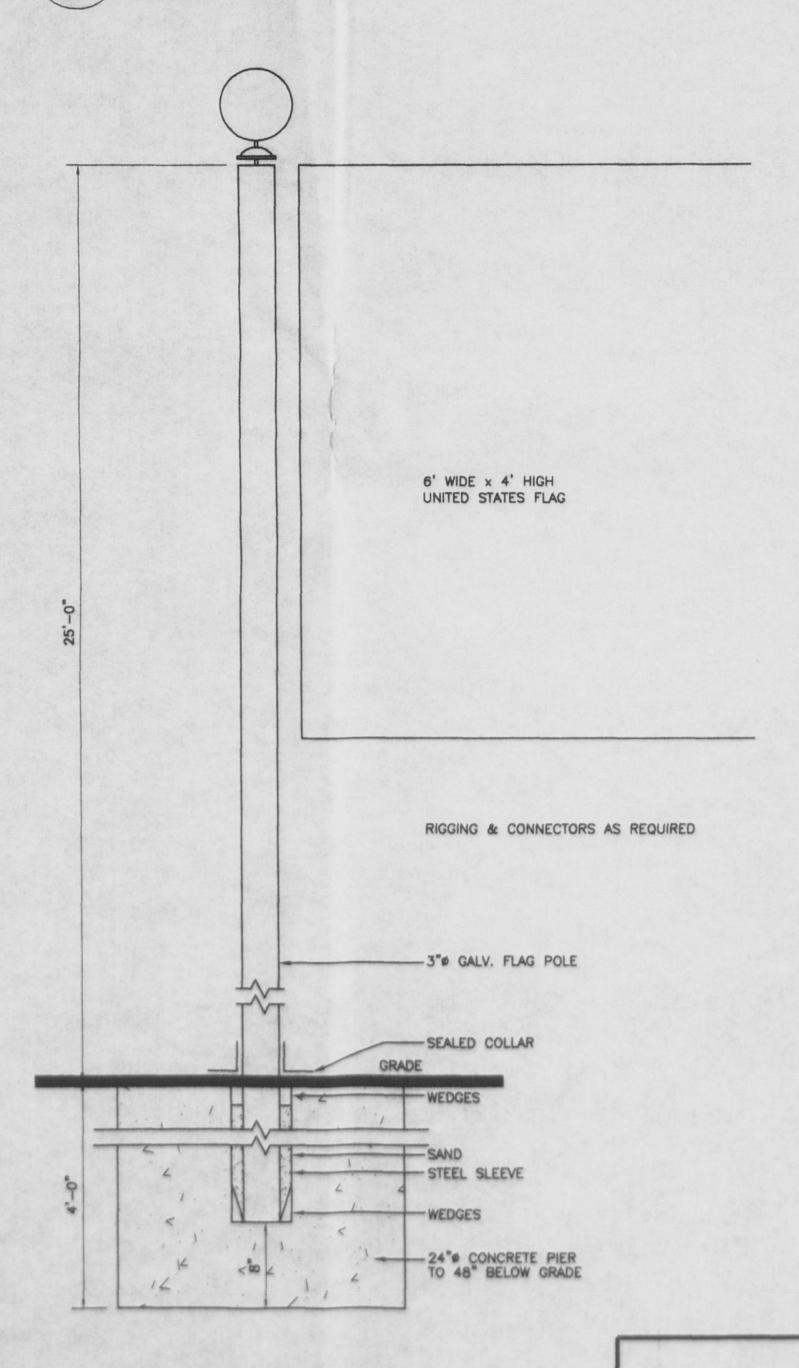

Flag Pole Detail
NTS

Sheet No.

SP6

Road

River

1/24/03


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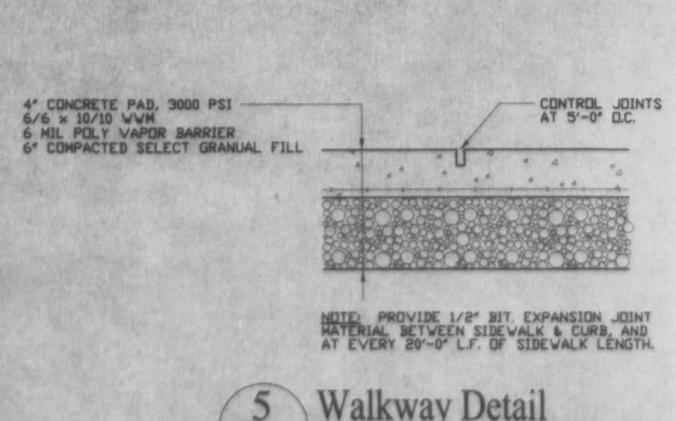
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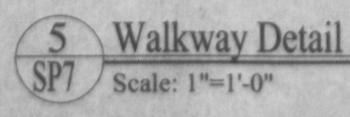
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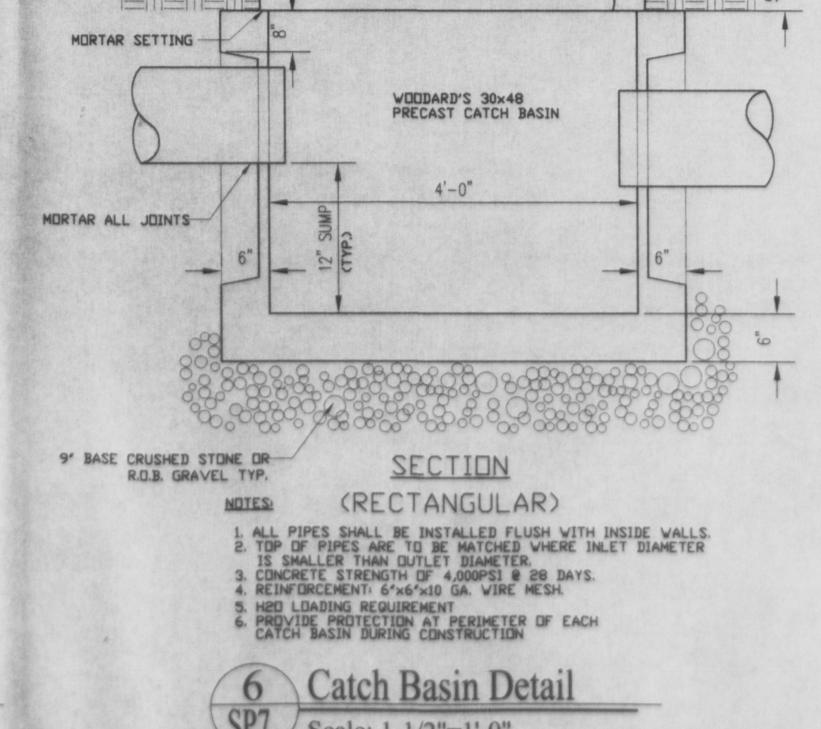
01-66


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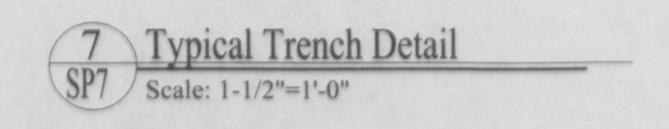









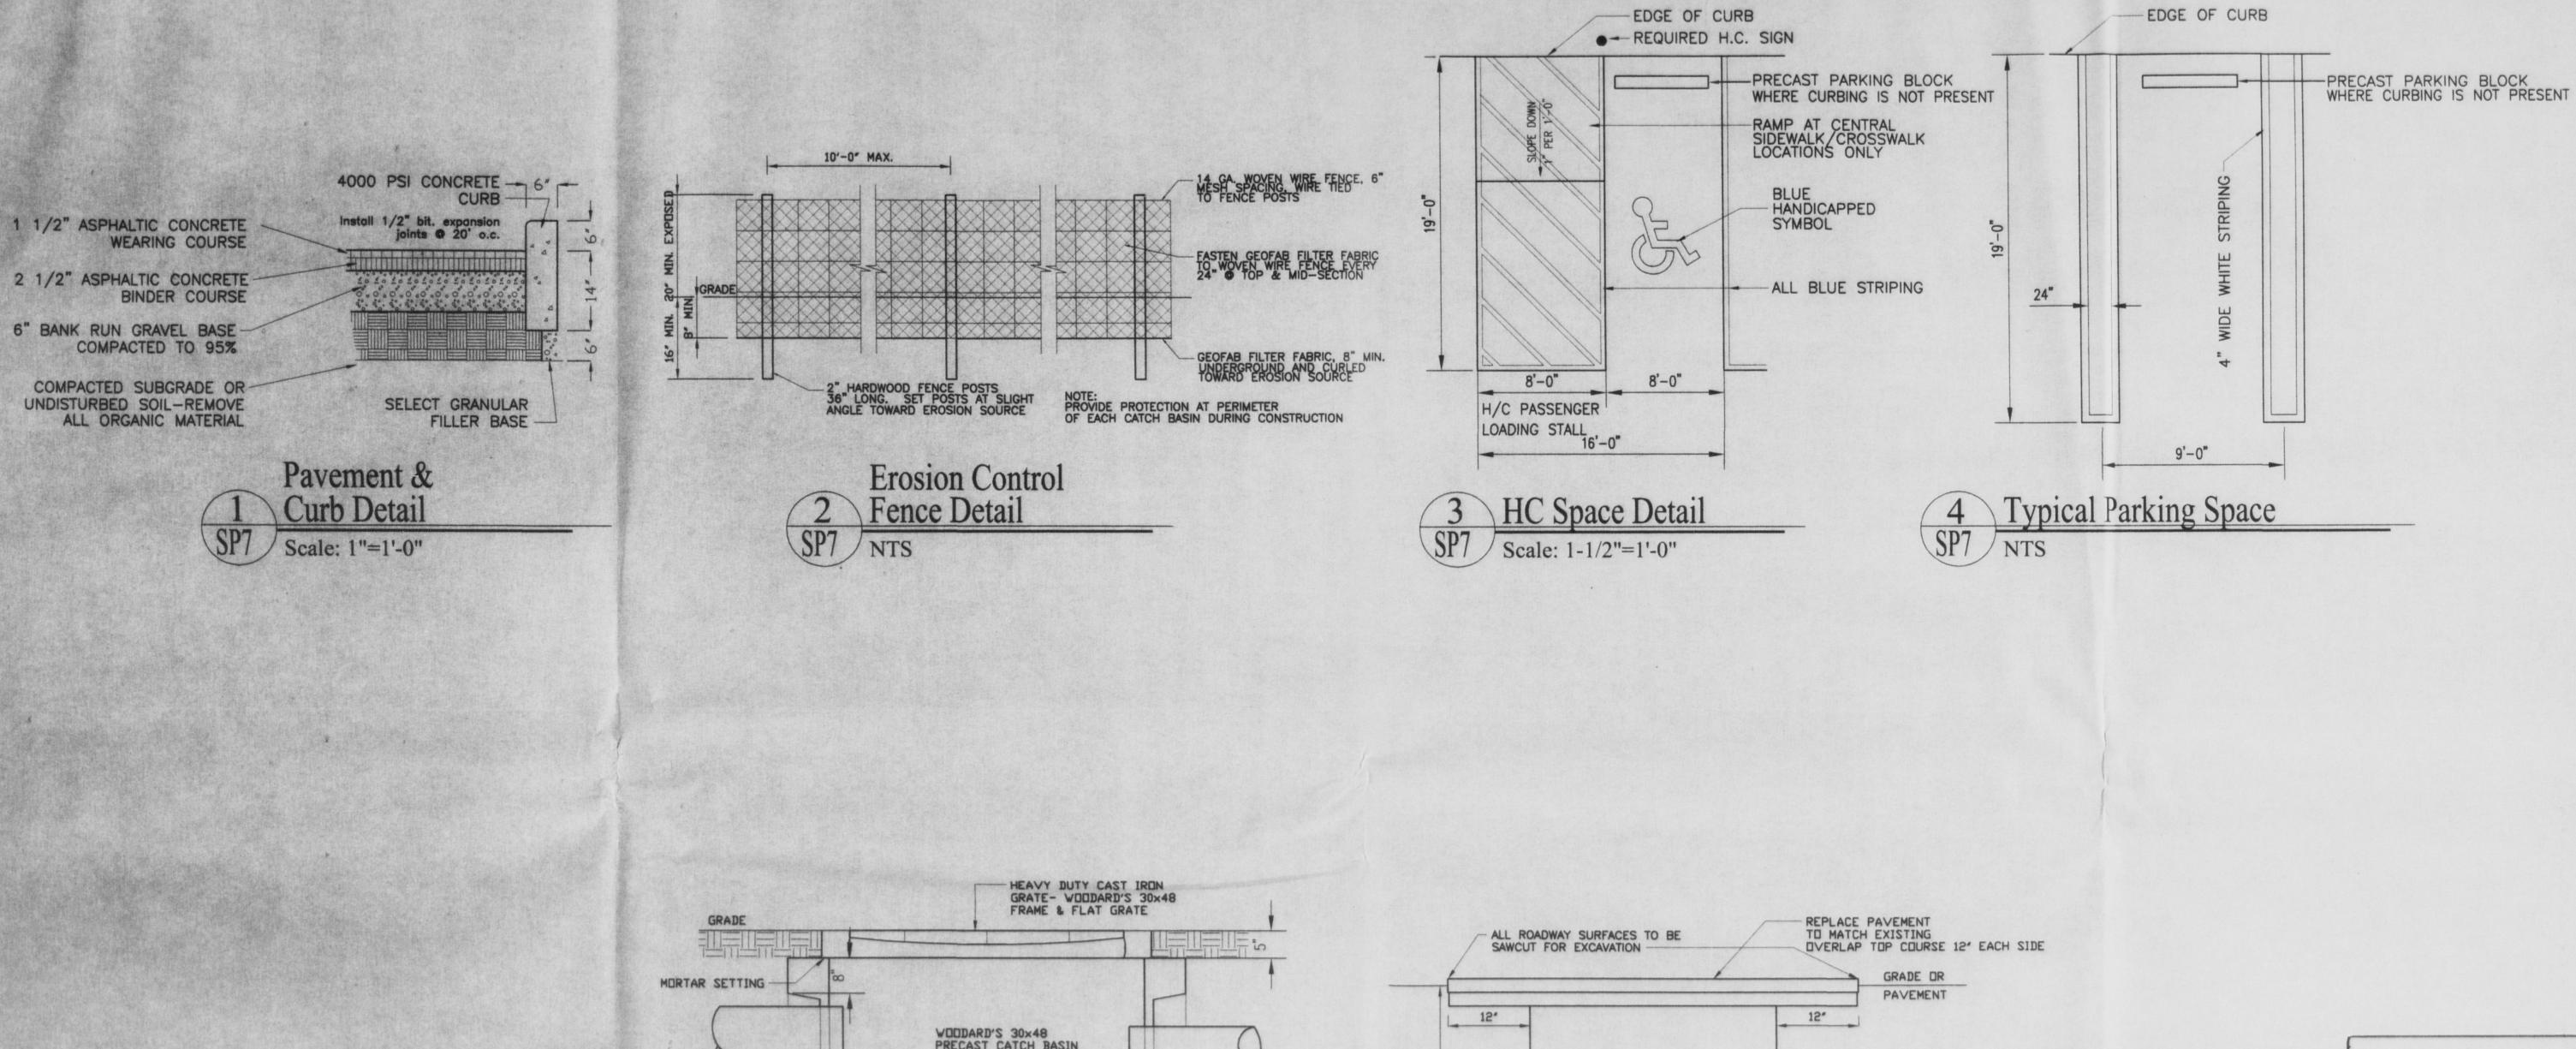

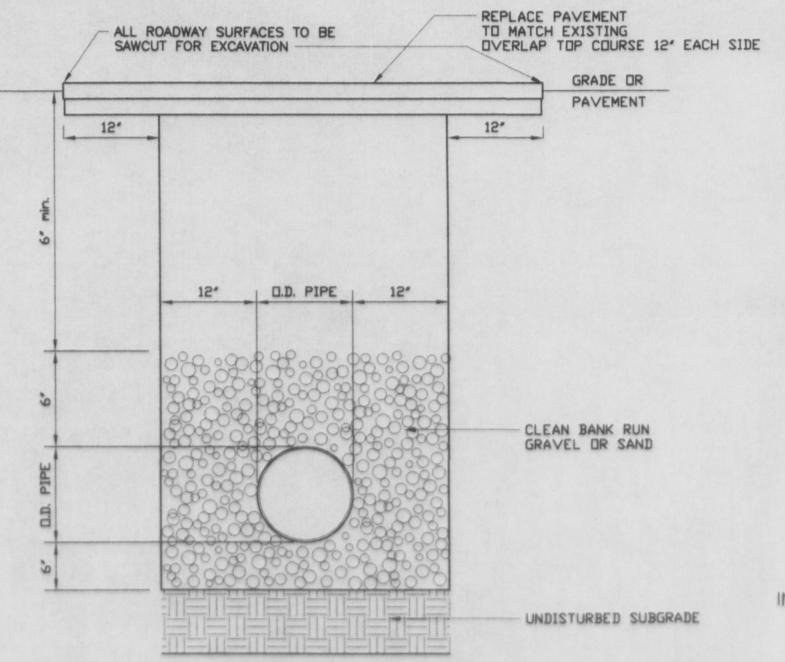

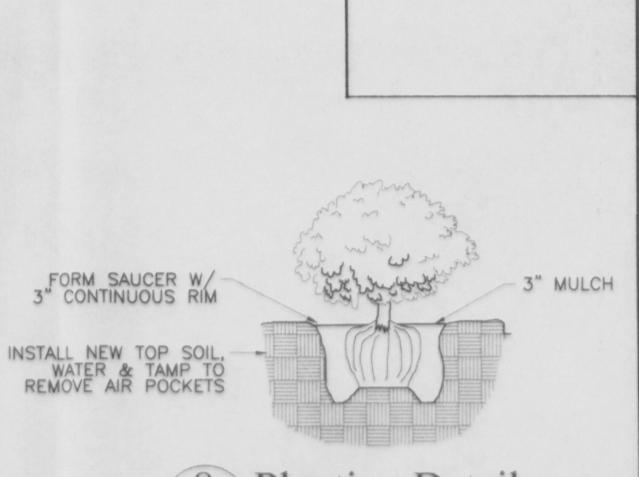

Planting Detail

Coppola Anthony

Road Medical Office/Retail Buil Rive

10.2.62 1/24/03

Drawn By: 8/20/02 SCALE:

AS NOTED

01-66 Sheet No.

DEEP HOLE LOCATION: A-D2 B-D2 A-P2 135' 175' 130' 170' 118' 129.8' A-D4 77.7' B-D4 127' A-P4 73.6' B-P4 154'

DEEP TEST DATA:

● D1 5'-5" DEEP 09/30/02 0-8" TOPSOIL 8"-65" ROCKY GRAVELY LOAM ROCK @ 65" NO WATER

● D2 6'-5" DEEP 09/30/02 0-6" TOPSOIL
6"-48" TIGHT GREY LOAM 48"-36" SILTY LOAM 36"-77" DARK ROCKY CLAY W/ SOME GRAVEL NO ROCK OR WATER

● D3 7'-0" DEEP 09/30/02 0-10" TOPSOIL 10"-84" VERY COMPACT CLAY 1/2 OF MOTTELING @ 2'


● D4 6-0" DEEP 09/30/02 0-6" TOPSOIL 8"-72" VERY ROCKY GRAVELY SILTY LOAM NO ROCK OR WATER


PERCOLATION DATA: * P1 24" DEEP 09/30/02 11:19 11:20 11:22 11:24 11:26 11:18 11:19 11:20 11:22 11:24 TIME :01 :02 STABILIZED PERCOLATION RATE: 02 MINUTES /INCH FINISH FAIL START 11:37 FAIL FAIL TIME FAIL
STABILIZED PERCOLATION RATE: FAIL 09/30/02

5 12:21 12:18 12:15 :03 12:11 12:14 12:09 12:18 12:11 STABILIZED PERCOLATION RATE: 03 MINUTES /INCH 24" DEEP 10:43 10:46 10:40 10:43 :03 :03 10:53 10:48 10:05 10:58 10:53 :05 11:03 10:58 :05

ALL TESTING AND DRAINAGE DESIGN PREPARED BY TACONIC DESIGN CONSULTANTS, INC.
SEE DRAINAGE REPORT DATED OCTOBER 1, 2002 FOR FURTHER INFORMATION.

STABILIZED PERCOLATION RATE: 05 MINUTES /INCH

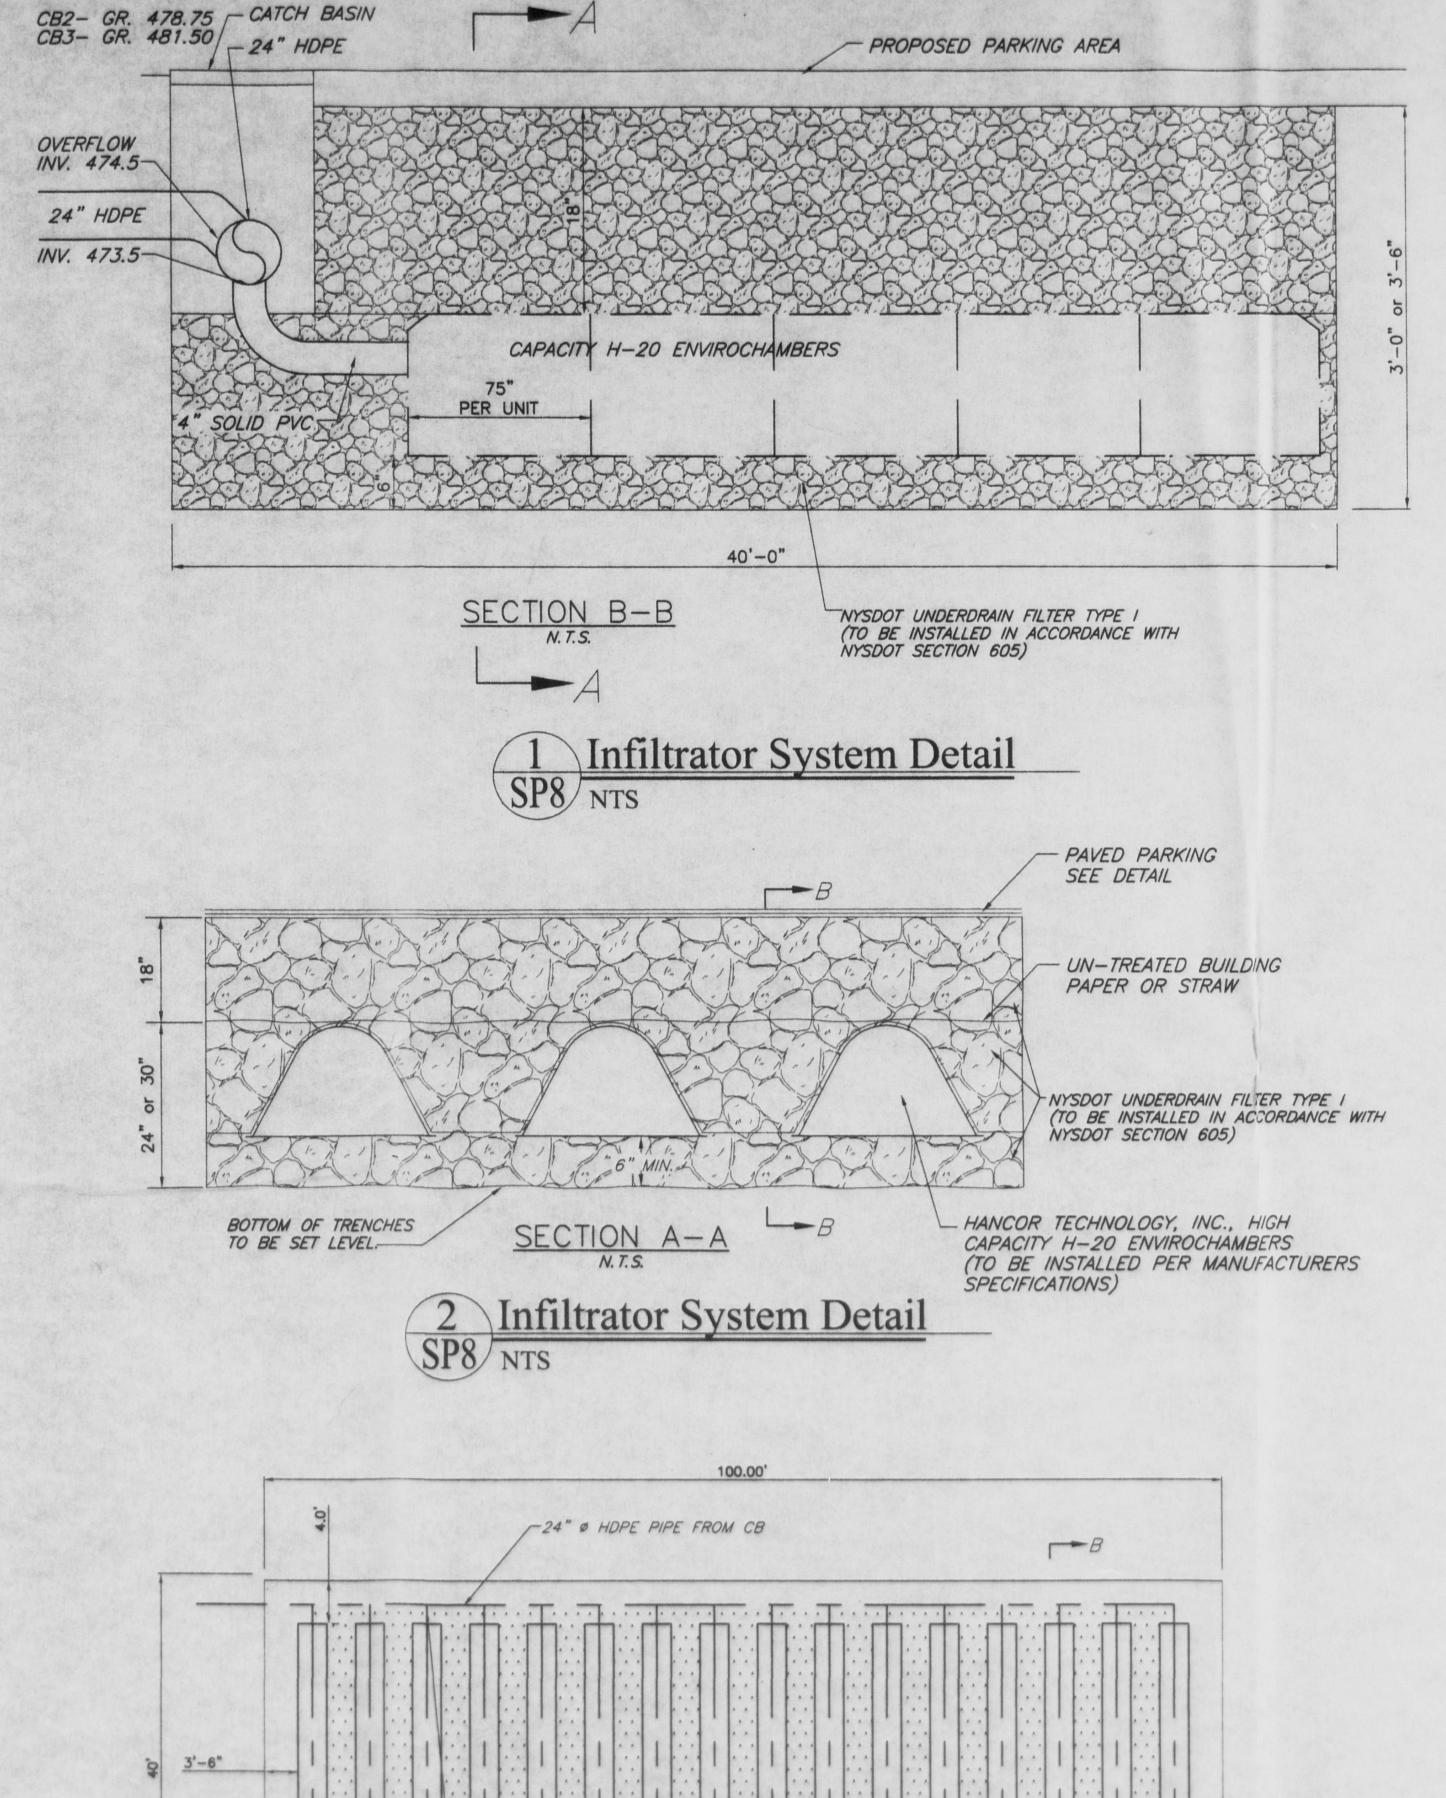

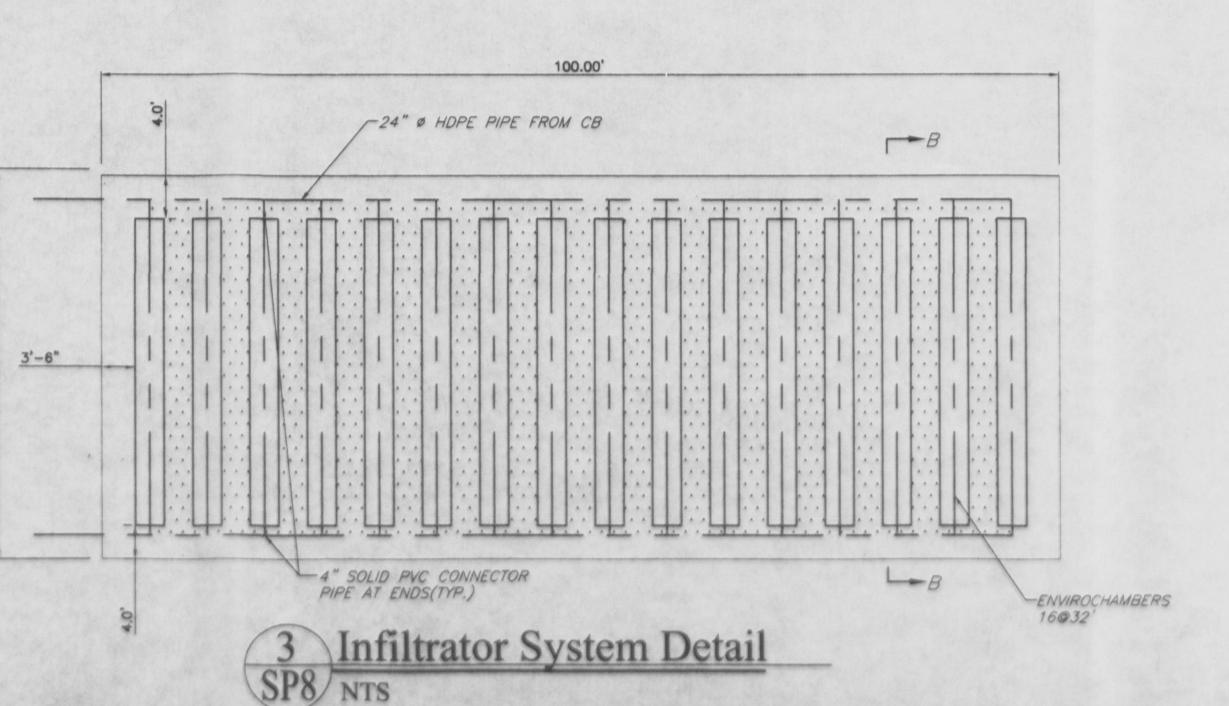

Anthony

icense Number: 018849

Road

River

Revisions

1/24/03

10/17/02

AS NOTED PROJECT NUMBER

01-66 Sheet No.